
Building 4000 Floors 3 and 4

Site Plan

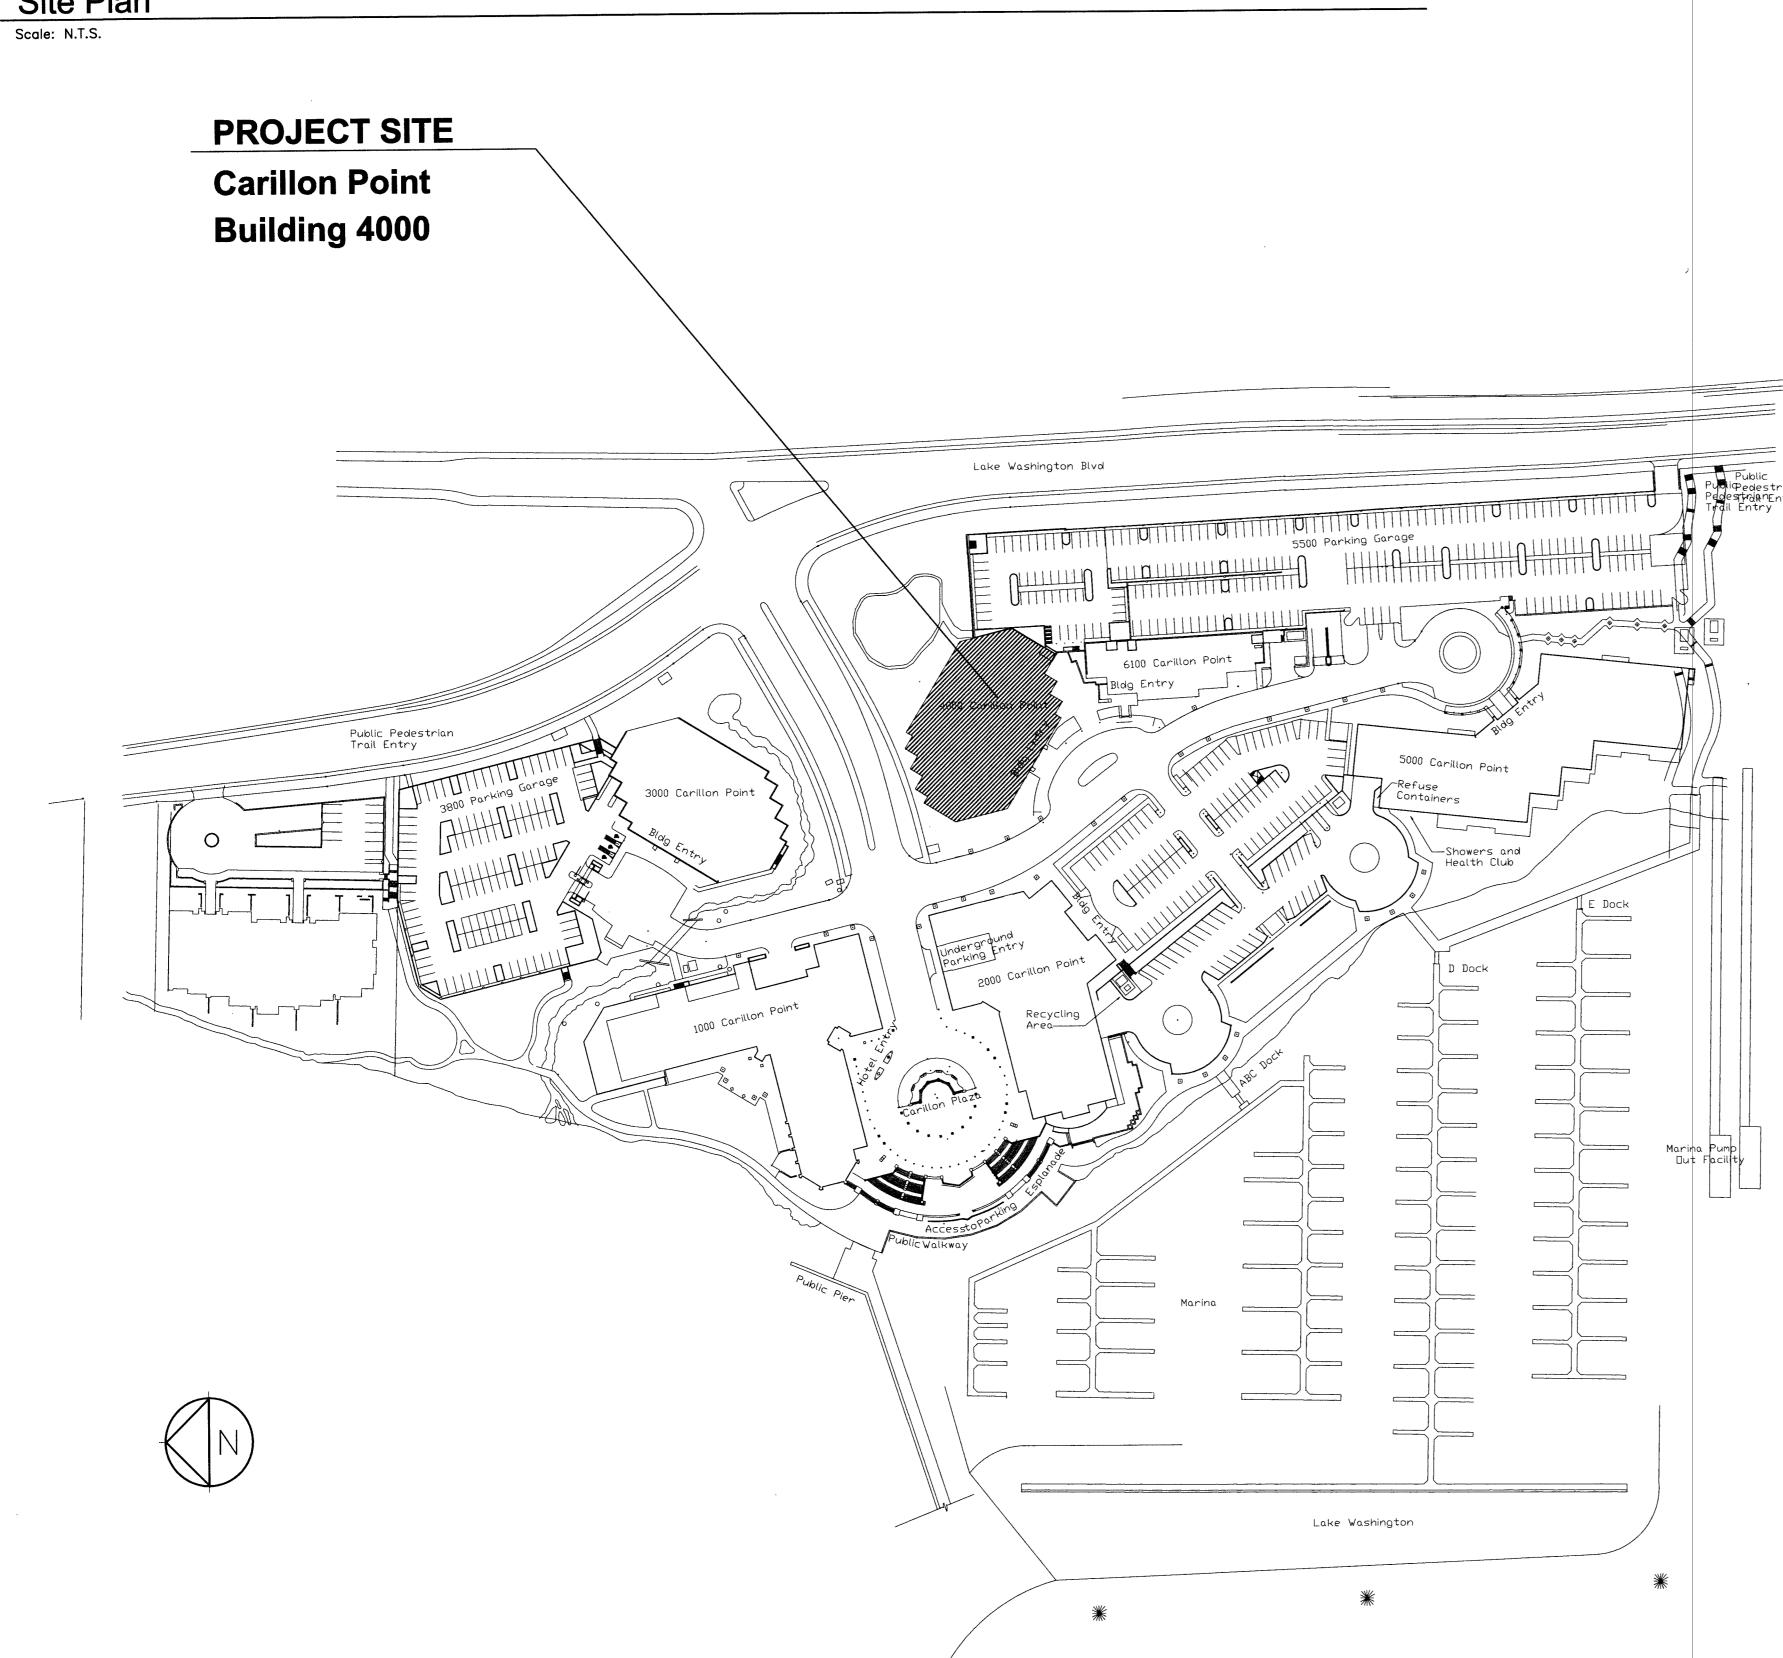

Deferred Submittals:

FIRE ALARM SYSTEM MECHANICAL PERMIT

ELECTRICAL PERMIT

FIRE SPRINKLER SYSTEM

PLUMBING PERMIT

 DOCUMENTS FOR DEFERRED SUBMITTAL ITEMS SHALL BE SUBMITTED TO THE REGISTERED. DESIGN PROFESSIONAL IN CHARGE (ARCHITECT/ENGINEER OF RECORD) FOR REVIEW PRIOR TO SUBMITTAL TO THE BUILDING OFFICIAL.

 NO WORK SHALL PROCEED ON ANY DEFERRED SUBMITTAL ITEMS UNTIL THE DOCUMENTS HAVE BEEN APPROVED BY THE BUILDING OFFICIAL AND PERMIT OBTAINED.

Drawing Index:

1-9.3

I-10.1

I-10.2

Cover Sheet & Site Plan 1-0.0 General Notes & Symbols 1-0.1 Exit Plan and Codes Summary - 3rd Floor I-CS.3 Exit Plan and Codes Summary - 4th Floor I-CS.4 Demolition Plan - 3rd Floor I-1.3 I**-**1.4 Demolition Plan - 4th Floor Floor Plan - 3rd Floor Floor Plan - 4th Floor 1-3.4 Demo Reflected Ceiling Plan - 3rd Floor 1-4.3.1 Reflected Ceiling Plan - 3rd Floor 1 - 4.3.2Demo Reflected Ceiling Plan - 4th Floor 1-4.4.1 Reflected Ceiling Plan - 4th Floor 1-4.4.2Finish Plan and Finish Schedule - 3rd Floor 1-6.3 Finish Plan and Finish Schedule - 4th Floor 1-6.4Interior Elevations 1-8.1 Enlarged Plans & Interior Elevations 1-8.2 Construction & Ceiling Details 1-9.1

Casework Details

Door Elevations & Details

Door Schedule And Hardware

Code Information:

APPLICABLE EDITIONS OF BUILDING CODES: PROJECT ADDRESS: CARILLON POINT B4000 2012 INTERNATIONAL BLDG CODE (IBC), 4100 CARILLON POINT FLOORS 3 & 4 2012 INTERNATIONAL FIRE CODE (IFC), INCL. APPENDIX B&C KIRKLAND, WA 98033 CONSTRUCTION TYPE: ENERGY CODE 2012 WASHINGTON STATE ENERGY CODE TYPE - 1A (WSEC), WAC 51-11 FULLY SPRINKLERED MECHANICAL 2012 INTERNATIONAL MECHANICAL CODE (IMC), WAC 51-52 PLA-15A COMMERCIAL 2008 NATIONAL ELECTRICAL CODE (NEC) (NFPA 70) + PART 1 AND PART 3, 2009 OCCUPANCY: WASHINGTON CITIES ELECTRICAL CODE WITH B - BUSINESS APPLICABLE RW 19.28 & WAC 296-46B TENANT SQUARE FOOTAGE: 51-56 & 51-57 INCL. APPENDIX CHAPTERS H (area of work) 36,894 TOTAL USABLE SF: & L - EXCL. SECTIONS L5-L7 & "LAWN SPRINKLER HEAD" FROM TABLE 6-4 OF FLOOR 3: 18,447 SF APPENDIX L FLOOR 4: 18,447 SF ZONING CODE CITY OF KIRKLAND ZONING CODE

Legal Description:


TAX PARCEL #: 172505-9058

POR GL 1 & 2 & BLKS F & G OF THE 2ND SUPL PLAT OF LK WN SH LDS TGW 2ND CL SHLDS ADJ ALL LY WLY OF W MGN LK WN BLVD-LESS POR N OF S LN OF N 1076.80 FT SD GL 1 & ITS WLY PROD - LESS POR THOF S OF LN BEG AT NXN 1902.66 FT S & PLW N LN GL 1 & W MGN LK WN BLVD TH S 03-09-13 E ALG W MGN 75 FT TO TPOB OF DESC LN TH N 88-35-53 W TO INNER HARBOR LN & TERMINUS THIS LN - LESS POR CONV BY REC 8907281497 AKA LOT B KK ALT LL #LL-91-50 REC 9104302101

ACCESSIBILITY PER ICC A117.1-2009 ACCESSIBLE AND

USABLE BUILDINGS AND FACILITIES

Vicinity Map:

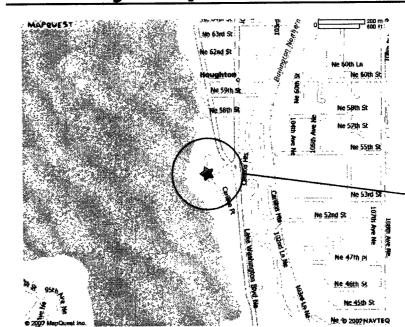

PROJECT LOCATION: CARILLON POINT BUILDING 4000 4100 CARILLON POINT KIRKLAND, WA 98033

FEB 26 2014.

Project Team:

Property Manager: CARILLON PROPERTIES

4100 CARILLON POINT KIRKLAND, WA 98033 TEL: 425-822-1700 FAX: 425-828-3094 KURT MILLER

kurt@carillonprop.com

Architect:

JPC ARCHITECTS, PLLC 909 112TH AVE NE SUITE 206 BELLEVUE, WA 98004 (425) 641-9200

CHRISTINE BENDA
ChristineB@jpcarchitects.com AMY NICHOLS AmyN@jpcarchitects.com

General Contractor:

JMS CONSTRUCTION 8575 WILLOWS ROAD NE REDMOND, WA 98052 206.510.4293 SMcGillis@jmsconstruction.com SAM MCGILLIS ARCHITE

S

Carillon Point B4000 Floors 3 & 4 4100 Carillon Pt. Kirkland, WA 98033

DESIGN DRAWN AN/CB CHECKED 13-0503



09.30.13 Progress Set 10.09.13 Permit / Bid Issue 1 10.22.13 ASI #1 2\11.25.13 ASI #2 <u>/3\12.17.13</u> CD Issue 4 12.20.13 ASI #3 5 01.09.14 ASI #4 6 01.29.14 ASI #5 /7\02.20.14 Permit Revision

Cover Sheet & Site

I-0.0

REVISION REFERENCE

INTERIOR ELEVATION SYMBOL

(REFER TO SHEET/KEY NOTES)

CABINETS, PLUMBING AND PLUMBING EQUIPMENT.

WOOD

WITHOUT WEIGHT

23. ANY CHANGE IN LIGHT FIXTURE PLACEMENT DUE TO INTERFERENCE OF MECHANICAL OR

24. ALL PERMITS INCLUDING FIRE, MECHANICAL, AND ELECTRICAL TO BE FILED SEPARATELY.

STRUCTURAL COMPONENTS MUST BE APPROVED BY THE ARCHITECT.

2

Carillon Point B4000

Floors 3 & 4 4100 Carillon Pt Kirkland, WA 98033

DESIGN DRAWN CHECKED NO.



09.30.13 Progress Set 10.09.13 Permit / Bid Issue 1\ 10.22.13 ASI #1 2 11.25.13 ASI #2 <u>∕3</u>\12.17.13 CD Issue 4\ 12.20.13 ASI #3 /5\ 01.09.14 ASI #4 **/6** 01.29.14 ASI #5 7\02.20.14 Permit Revision


General Notes 8



09.30.13 Progress Se 1 10.22.13 ASI #1 2 11.25.13 ASI #2 3 12.17.13 CD Issue /4\ 12.20.13 ASI #3 √5 01.09.14 ASI #4 6 01.29.14 ASI #5 7\02.20.14 Permit Revision

Exit Plan and Codes Summary - 3rd Floor

© 2013, JPC Architects, PLLC

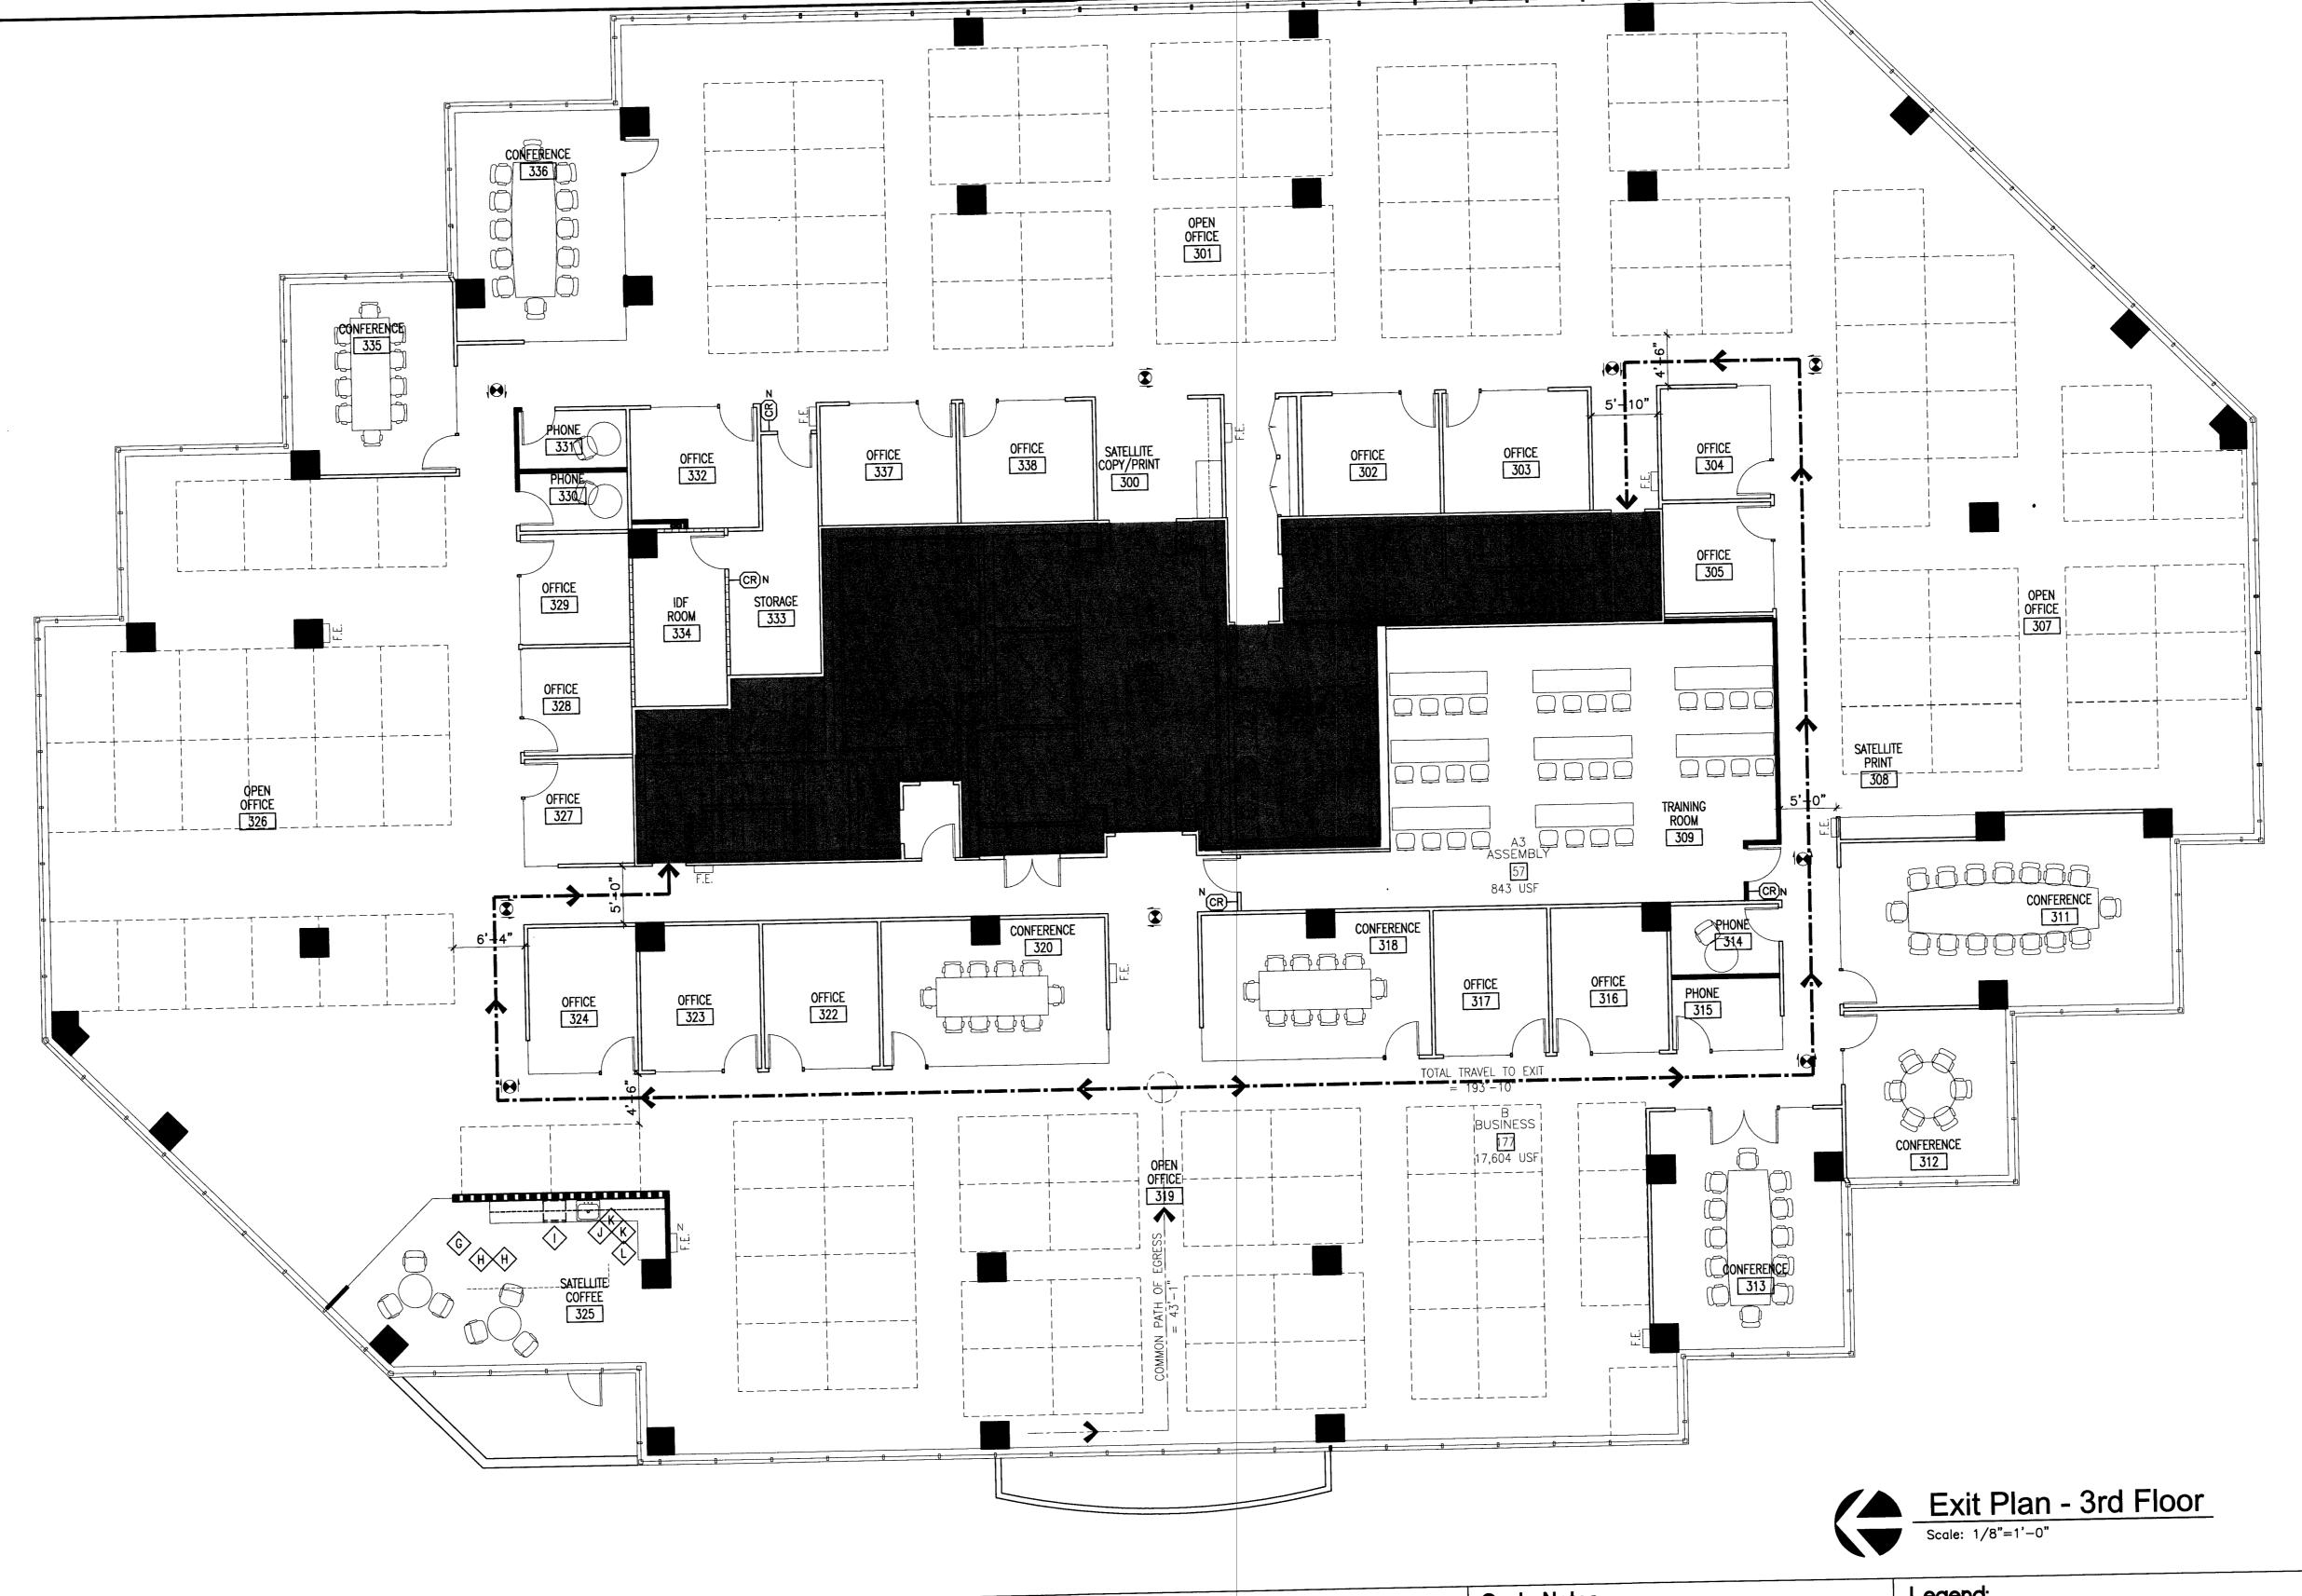

General Notes:

- EGRESS LIGHTING SHALL BE DESIGNED BY A LICENSED ELECTRICAL ENGINEER BASED ON FINAL FLOOR PLAN(S) AND THE MOST CURRENT (IN FORCE) ISSUE OF THE IBC, IEC AND LOCAL CODES/ORDINANCES. THE ENGINEER MAY USE THE ARCHITECTS EXIT DIAGRAM AS STARTING POINT FOR A BASIS OF DESIGN. HOWEVER, IT SHALL REMAIN THE SOLE RESPONSIBILITY OF THE ENGINEER TO COMPLETE A SCOPE OF WORK THAT ADDRESSES ALL EGRESS LIGHTING I.E.; ROOMS, SPECIAL SPACES, PATHWAYS, ETC. PER THE AFOREMENTIONED CODES. FINAL EGRESS LIGHTING QUANTITIES AND LOCATIONS SHALL BE DETERMINED BY BUILDING AND FIRE INSPECTOR'S FIELD PLACEMENT DETERMINATION
- EGRESS LIGHTS METHODOLOGIES AND MATERIALS (MANUF. TYPE/STYLE) SHALL BE APPROVED BY THE ARCHITECT AND/OR BUILDING OWNER PRIOR TO COMPLETION OF BUDGETING, PERMIT SUBMITTALS AND/OR CONSTRUCTION.
- REFER TO IBC 2012 CHAPTER 29 TABLE 2902.1 FOR PLUMBING FIXTURE CALCULATIONS, MINIMUM FIXTURES REQUIRED.
- (1) SERVICE SINK IS REQUIRED UNLESS OCCUPANT LOAD IS 15 OR FEWER.

- 5. TOTAL 'B' OCCUPANT LOAD = 177 OCCUPANTS. ASSUME EQUAL PARTS MALE AND FEMALE = 89 MALE AND 89 FEMALE. (1) STALL IS REQUIRED PER 25 OCCUPANTS FOR THE FIRST 50 OCCUPANTS, (1) PER 50 FOR THE REMAINDER EXCEEDING 50 (PER SEX).
- TOTAL 'A-3' OCCUPANT LOAD = 57 OCCUPANTS. ASSUME EQUAL PARTS MALE AND FEMALE = 29 MALE AND 29 FEMALE. (1) STALL IS REQUIRED PER 125 MALES. (1) STALL IS REQUIRED PER 65 FEMALES.
- (4) STALLS ARE REQUIRED FOR MALES AND (4)STALLS + (2)URINALS ARE (4) STALLS ARE REQUIRED FOR FEMALES AND (5) STALLS ARE PROVIDED.
- 6. IN 'B,' (1) LAVATORY IS REQUIRED PER 40 OCCUPANTS FOR THE FIRST 80 OCCUPANTS, (1) PER 80 FOR THE REMAINDER EXCEEDING 80. IN 'A-3,' (1) LAVATORY IS REQUIRED PER 200 OCCUPANTS. (3) LAVATORIES ARE REQUIRED (PER SEX) AND (3) ARE PROVIDED (PER
- 7. IN 'B,' (1) DRINKING FOUNTAIN IS REQUIRED PER 100 OCCUPANTS. IN 'A-3,' (1) DRINKING FOUNTAIN IS REQUIRED PER 1000 OCCUPANTS. (2) DRINKING FOUNTAINS ARE REQUIRED.

Code Notes:

- TOTAL USABLE AREA IN 'B': 17,604 USF TOTAL USABLE AREA IN 'A-3': 843 USF
- IN 'B': 17,604 SF/100 = 177 OCCUPANTS IN 'A-3': 843 SF/15 = 57 OCCUPANTS: 234/2 = 117 PER EXIT.
- EGRESS EXIT WIDTH: PER IBC SECTION 1005.3.2: 234 X 0.2 = 46.8" MINIMUM EXIT WIDTH
- IN 'B' AREA, MINIMUM (2) EXITS REQUIRED PER IBC 1015 & 1021, (2) EXITS HAVE BEEN PROVIDED. IN 'A-3' AREA, MINIMUM (2) EXITS REQUIRED PER IBC 1015, (2) EXITS HAVE BEEN PROVIDED.
- ALL CONFERENCE ROOMS UNDER 50 OCCUPANTS (OR 750 SF) TO BE CONSIDERED 'B' OCCUPANCY PER IBC 303.1.

Legend:

- "COMMON PATH OF EGRESS TRAVEL" IS LESS THAN 100'-0" AS ALLOWED FOR SPRINKLERED BUILDINGS WITH QUICK RESPONSE HEADS, PER 2012 IBC 1014.3, EXCEPTION #1.
- "TOTAL EXIT ACCESS TRAVEL DISTANCE" IS LESS THAN 300'-0" AS ALLOWED FOR SPRINKLERED BUILDINGS WITH QUICK
- RESPONSE HEADS.
 - X DENOTES NUMBER OF OCCUPANTS




09.30.13 Progress Set 10.09.13 Permit / Bid Issue 10.22.13 ASI #1 2 11.25.13 ASI #2 3 12.17.13 CD Issue 12.20.13 ASI #3 **5**01.09.14 ASI #4 **6** 01.29.14 ASI #5 7 02.20.14 Permit Revision

Exit Plan and Codes Summary - 4th Floor

I-CS.4

© 2013, JPC Architects, PLLC

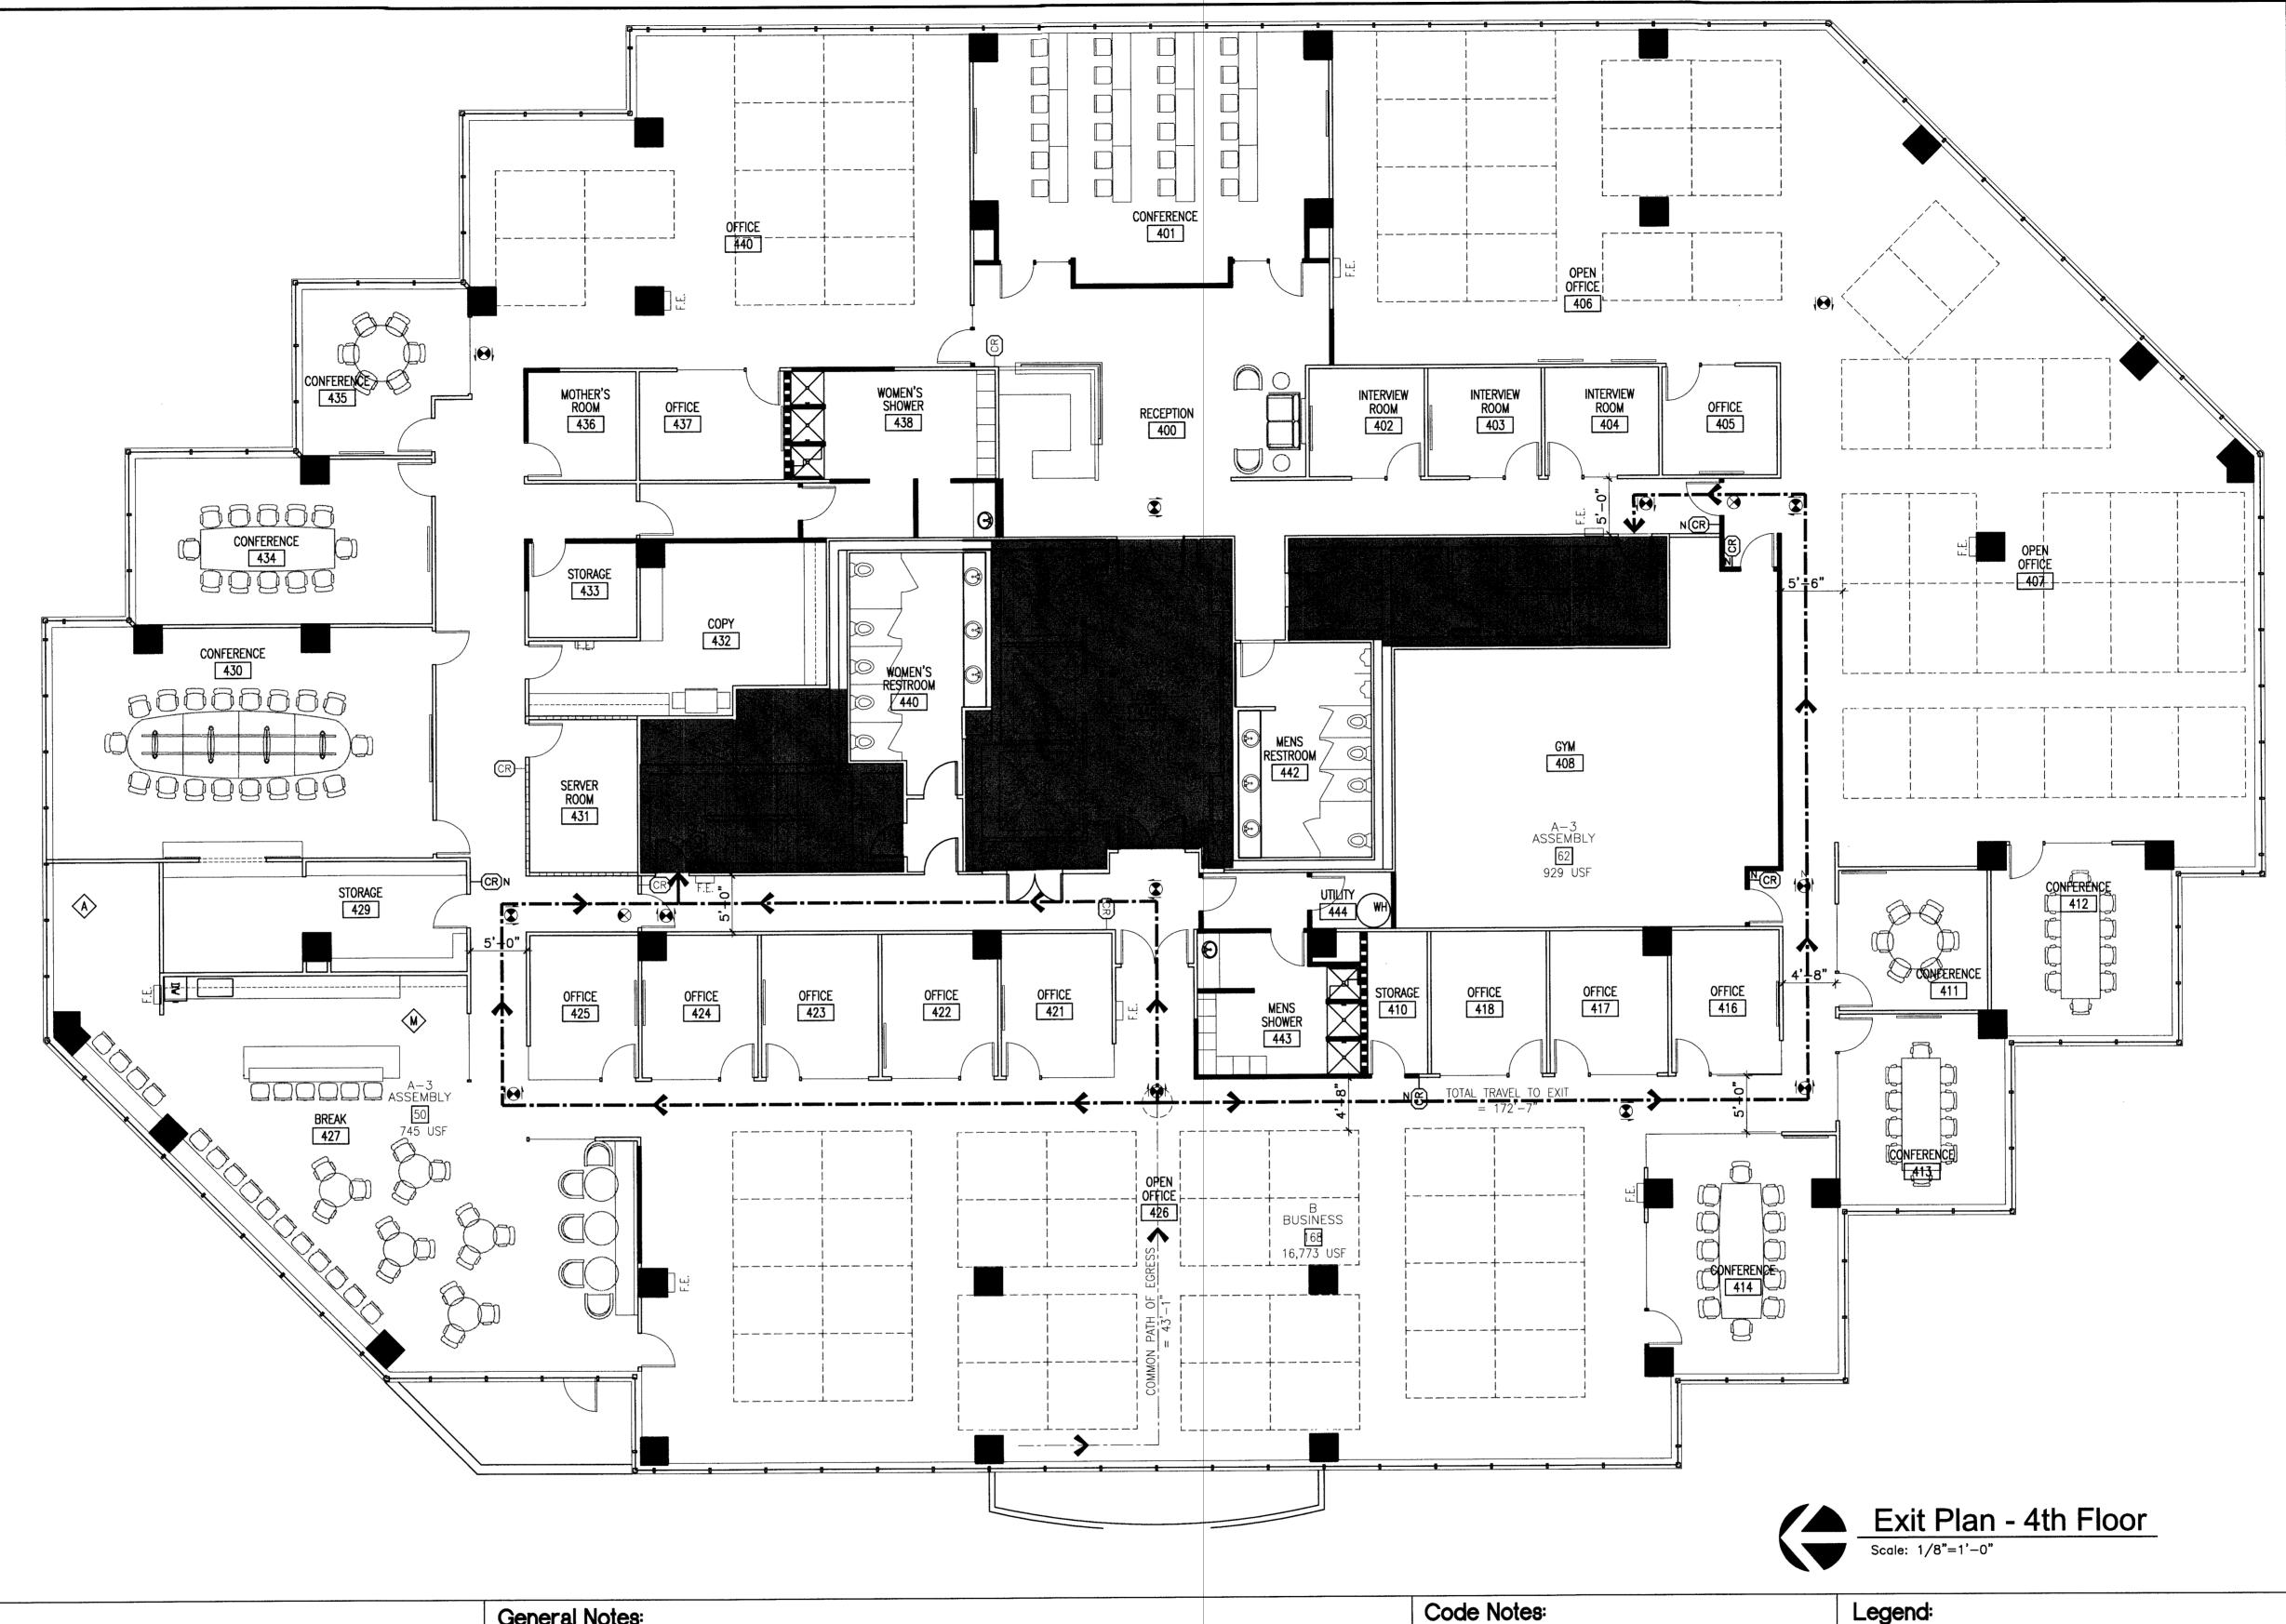

General Notes:

- EGRESS LIGHTING SHALL BE DESIGNED BY A LICENSED ELECTRICAL ENGINEER BASED ON FINAL FLOOR PLAN(S) AND THE MOST CURRENT (IN FORCE) ISSUE OF THE IBC, IEC AND LOCAL CODES/ORDINANCES. THE ENGINEER MAY USE THE ARCHITECTS EXIT DIAGRAM AS STARTING POINT FOR A BASIS OF DESIGN. HOWEVER, IT SHALL REMAIN THE SOLE RESPONSIBILITY OF THE ENGINEER TO COMPLETE A SCOPE OF WORK THAT ADDRESSES ALL EGRESS LIGHTING I.E.; ROOMS, SPECIAL SPACES, PATHWAYS, ETC. PER THE AFOREMENTIONED CODES. FINAL EGRESS LIGHTING QUANTITIES AND LOCATIONS SHALL BE DETERMINED BY BUILDING AND FIRE INSPECTOR'S FIELD PLACEMENT DETERMINATION
- EGRESS LIGHTS METHODOLOGIES AND MATERIALS (MANUF. TYPE/STYLE) SHALL BE APPROVED BY THE ARCHITECT AND/OR BUILDING OWNER PRIOR TO COMPLETION OF BUDGETING, PERMIT SUBMITTALS AND/OR CONSTRUCTION.
- REFER TO IBC 2012 CHAPTER 29 TABLE 2902.1 FOR PLUMBING FIXTURE CALCULATIONS, MINIMUM FIXTURES REQUIRED.
- (1) SERVICE SINK IS REQUIRED UNLESS OCCUPANT LOAD IS 15 OR

- 5. TOTAL 'B' OCCUPANT LOAD = 168 OCCUPANTS. ASSUME EQUAL PARTS MALE AND FEMALE = 84 MALE AND 84 FEMALE. (1) STALL IS REQUIRED PER 25 OCCUPANTS FOR THE FIRST 50 OCCUPANTS, (1) PER 50 FOR THE REMAINDER EXCEEDING 50 (PER SEX).
- TOTAL 'A-3' OCCUPANT LOAD = 112 OCCUPANTS. ASSUME EQUAL PARTS MALE AND FEMALE = 56 MALE AND 56 FEMALE. (1) STALL IS REQUIRED PER 125 MALES.
- (1) STALL IS REQUIRED PER 65 FEMALES.
- (4) STALLS ARE REQUIRED FOR MALES AND (4)STALLS + (2)URINALS ARE (4) STALLS ARE REQUIRED FOR FEMALES AND (5) STALLS ARE PROVIDED.
- 6. IN 'B,' (1) LAVATORY IS REQUIRED PER 40 OCCUPANTS FOR THE FIRST 80 OCCUPANTS, (1) PER 80 FOR THE REMAINDER EXCEEDING 80. IN 'A-3,' (1) LAVATORY IS REQUIRED PER 200 OCCUPANTS. (3) LAVATORIES ARE REQUIRED (PER \$EX) AND (3) ARE PROVIDED (PER
- 7. IN 'B,' (1) DRINKING FOUNTAIN IS REQUIRED PER 100 OCCUPANTS. IN 'A-3,' (1) DRINKING FOUNTAIN IS REQUIRED PER 1000 OCCUPANTS. (2) DRINKING FOUNTAINS ARE REQUIRED.

Code Notes:

- TOTAL USABLE AREA IN 'B': 16,773 USF TOTAL USABLE AREA IN 'A-3': 1,674 USF
- IN 'B': 16,773 SF/100 = 168 OCCUPANTSIN 'A-3': 1,674 SF/15 = 112 OCCUPANTS: 280/2 = 140 PER EXIT.
- EGRESS EXIT WIDTH: PER IBC SECTION 1005.3.2: 280 X 0.2 = 56" MINIMUM EXIT WIDTH
- IN 'B' AREA, MINIMUM (2) EXITS REQUIRED PER IBC 1015 & 1021, (2) EXITS HAVE BEEN PROVIDED. IN 'A-3' AREA, MINIMUM (2) EXITS REQUIRED PER IBC 1015, (2) EXITS HAVE BEEN PROVIDED.
- ALL CONFERENCE ROOMS UNDER 50 OCCUPANTS (OR 750 SF) TO BE CONSIDERED 'B' OCCUPANCY PER IBC 303.1.

- "COMMON PATH OF EGRESS TRAVEL" IS LESS THAN 100'-0" AS ALLOWED FOR SPRINKLERED BUILDINGS WITH QUICK RESPONSE HEADS, PER 2012 IBC 1014.3, EXCEPTION #1.
- "TOTAL EXIT ACCESS TRAVEL DISTANCE" IS LESS THAN 300'-0" AS ALLOWED FOR SPRINKLERED BUILDINGS WITH QUICK RESPONSE HEADS.
- X DENOTES NUMBER OF OCCUPANTS

Demolition Plan Key Notes:

- EXISTING FINISH FLOORING TO BE DEMOLISHED THROUGHOUT SCOPE OF PROJECT, UNLESS NOTED OTHERWISE. DIRECT GLUE BROADLOOM CARPET TO BE REMOVED FROM UNDER EXISTING FURNITURE WHICH WILL NOT BE MOVED. PATCH AND REPAIR AFFECTED SUBSTRATE AS RQD. FOR INSTALLATION OF NEW FLOORING AND BASE MATERIALS.
- DEMOLISH ELECTRICAL, LOW VOLTAGE AND LIFE SAFETY EQUIPMENT/DEVICES (INCLUDING LOW VOLTAGE CABLING) AS REQUIRED DUE TO DEMOLITION. AT LOCATIONS WHERE ELECTRICAL IS TO BE REMOVED, TERMINATE WIRING AT CLOSEST JUNCTION BOX OR DEMOLISH WIRING BACK TO PANEL.
 - REMOVE AND SALVAGE EXISTING DOORS, FRAMES, RELITES AND HARDWARE FOR REUSE AND REINSTALLATION WHERE PRACTICAL. REFER TO FLOOR PLAN FOR ADDITIONAL INFORMATION.
- PROTECT EXISTING (TO REMAIN) MILLWORK DURING SCOPE OF DEMOLITION. RECONDITION EXISTING CABINETRY, INCLUDING BUT NOT LIMITED TO ADJUSTMENT OF HINGES, SUPPLEMENT MISSING AND/OR DAMAGED COMPONENTS (SHELVES, DRAWERS, HARDWARE ETC.), REPAIR FACIAL/STRUCTURAL DAMAGE, RE-ADHERE LAMINATE AND CLEAN TO A "LIKE NEW" CONDITION.
- DEMOLISH AND DISPOSE OF EXISTING PLUMBING/FIXTURES. TERMINATE AND CAP ALL EXISTING SUPPLY/WASTE LINES BEHIND WALL AND/OR FLOOR. PATCH AND REPAIR AFFECTED AREAS. INCLUDING BUT NOT LIMITED TO WALLS, FLOORS AND CEILINGS AS REQUIRED MATCHING EXISTING FINISH MATERIALS, UNO.
- EXPOSE EXISTING COLUMNS IN OPEN OFFICE AREAS (ENCLOSED
- ROOMS TO REMAIN WRAPPED). REFER TO FLOOR PLAN:
- KEEP EXISTING COLUMNS FINISHED/WRAPPED AS-IS REMOVE AND SALVAGE DEMOLISH ALL EXISTING WHITE BOARDS. FOR REINSTALLATION. COORDINATE NEW LOCATIONS WITH TENANT: ANY
- DAMAGED WHITE BOARDS TO BE DISCARDED: REMOVE EXISTING B/S CARD READERS AND RETURN TO BUILDING STOCK. REFER TO FLOOR PLAN FOR NEW CARD READER LOCATIONS. AT ANY LOCATIONS WHERE AN EXISTING CARD READER IS GETTING REPLACED WITH A NEW DEVICE IN SAME LOCATION, COORDINATE ANY RE-USE OF WALL OPENING, WIRING, ETC. AS APPLICABLE FOR NEW
- REMOVE EXISTING RECESSED FE CABINET AND REINSTALL AT NEW
- EXISTING FLOORING TO REMAIN AT THIS LOCATION.
- EXISTING FINISHED FLOORING AND WALL TILE TO BE DEMOLISHED IN EXISTING RESTROOMS. PATCH AND REPAIR AFFECTED SUBSTRATE AS RQD FOR INSTALLATION OF NEW FLOOR AND WALL TILES.
- EXISTING TOILET PARTITIONS TO BE REUSED. REPAIR AND REALIGN PARTITIONS AND REPLACE ANY DAMAGED HARDWARE. APPLY ELECTROSTATIC PAINT-P3.
- EXISTING COUNTERTOPS & TOILET ACCESSORIES TO REMAIN. DEMOLISH EXISTING MIRRORS.

 DEMOLISH EXISTING COUNTERTOP & BACKSPLASH AT SATELLITE COPY/PRINT 300 & 308 AND REPLACE WITH NEW PLAM (PL1) REFER TO FINISH PLAN FOR ADDITIONAL INFORMATION.

Demolition Notes:

- OBTAIN DEMOLITION PERMITS AND INCLUDE ALL COSTS OF SAME IN CONTRACT PRICE.
- FURNISH ALL LABOR AND MATERIALS/EQUIPMENT TO COMPLETE DEMOLITION AND REMOVAL OF ALL ITEMS AS INDICATED.
- CONTRACTOR SHALL KEEP CONSTRUCTION AREA FREE OF DUST
- AND DEBRIS FOR THE DURATION OF CONSTRUCTION. IF ANY QUESTIONS ARISE AS TO THE REMOVAL OF ANY MATERIAL,
- AT COMPLETION OF DEMOLITION WORK, THE CONSTRUCTION AREA(S) SHALL BE LEFT IN "BROOM CLEAN" CONDITION. ALL DEBRIS AND MISCELLANEOUS MATERIAL SHALL BE REMOVED.
- ALL DEBRIS REMOVAL SHALL BE PERFORMED IN ACCORDANCE WITH BUILDING MANAGEMENT REQUIREMENTS AND PROCEDURES.
- AS DIRECTED BY BUILDING MANAGEMENT, ALL DOORS, FRAMES, HARDWARE, MECHANICAL ITEMS, PLUMBING FIXTURES, LIGHT FIXTURES (INCLUDING DOWNLIGHTS AND FLUORESCENTS), AND SPECIAL EQUIPMENT SHOWN TO BE REMOVED, SHALL BE CLEAN AND FREE OF DEFECTS, PROTECTED, SAVED AND REUSED AS DIRECTED HEREIN, OR RETURNED TO BUILDING STOCK.
- IN PARTITIONS TO BE REMOVED, REMOVE AND CAP ALL OUTLETS, SWITCHES, WIRES, THERMOSTATS, ETC., TO THEIR SOURCE.
- CONTRACTOR SHALL BE RESPONSIBLE FOR PATCHING AND/OR REPAIRING ANY DAMAGE CAUSED BY HIM OR HIS SUBCONTRACTORS TO EXISTING CONSTRUCTION IN ELEVATOR LOBBY, PUBLIC CORRIDORS, RESTROOMS OR TENANT SPACES. REFINISH TO MATCH EXISTING ADJACENT FINISH, OR AS NOTED HEREIN.
- 10. NO EXISTING SMOKE DETECTOR, PUBLIC ADDRESS SPEAKER, FIRE ALARM BOX OR SIMILAR DEVICE, INCLUDING THE ASSOCIATED WIRING SHALL BE DAMAGED DURING DEMOLITION AND SUBSEQUENT CONSTRUCTION. RELOCATION OF SMOKE DETECTORS, PUBLIC ADDRESS SPEAKERS AND FIRE ALARM EQUIPMENT, NECESSITATED BY NEW CONSTRUCTION, SHALL BE ACCOMPLISHED AS A FIRST PRIORITY, AND PER THE PLANS. NO ACTIVE SMOKE DETECTOR SHALL BE COVERED OR OTHERWISE REMOVED OR USED FOR OTHER THAN IT'S INTENDED PURPOSE.
- REMOVAL OF ANY EQUIPMENT, CABLING SWITCHES, AND CONDUIT PERTAINING TO DATA/COMMUNICATIONS AND TELEPHONE SHALL BE VERIFIED WITH TELEPHONE COMPANIES AND TENANT.
- 12. REMOVE ALL EXISTING MATERIALS WHICH WOULD CAUSE RISES OR DEPRESSIONS IN NEW FLOORING SURFACE, SUCH AS FASTENERS, OUTLET CORES, COVER PLATES, RESILIENT FLOOR COVERINGS, CARPET, CARPET PAD, FLASH PATCH, CONCRETE FILL, PLYWOOD,
- 13. DEMOLITION IS NOT NECESSARILY LIMITED TO WHAT IS SHOWN ON DRAWINGS. THE INTENT IS TO INDICATE THE GENERAL SCOPE OF DEMOLITION REQUIRED TO COMPLETE THE WORK IN ACCORDANCE WITH THE CONTRACT DRAWINGS.
- 14. RATED WALLS SHALL NOT BE PENETRATED UNLESS THE RATING IS MAINTAINED.
- 15. DISPOSAL: ALL DEBRIS REMOVED FROM THE SITE SHALL BE RECYCLED AS MUCH AS PRACTICAL AND ALLOWED BY LAW.

J-BOX FOR TENANT PROVIDED SYSTEMS FURNITURE.

PULL STRING

♦ WALL TAG

(CR)— PROXIMITY CARD READER

NO DESIGNATION = EXISTING

D = DEMOLISH

✓ VOICE/DATA RECEPTACLE. CONTRACTOR TO PROVIDE MUD RING AND

Carillon Point B4000 Floors 3 & 4 4100 Carillon Pt. Kirkland, WA 98033

DESIGN JPC DRAWN CHECKED 13-0503



09.30.13 Progress Set 10.09.13 Permit / Bid Issue /1\ 10.22.13 ASI #1 2 11.25.13 ASI #2 <u>3</u>12.17.13 CD Issue 4 12.20.13 ASI #3 5 01.09.14 ASI #4 6 01.29.14 ASI #5 7\02.20.14 Permit Revision

Demolition Plan - 3rd Floor

ARCHITEC

000 112th Assessing NE Courts 204

Carillon Point B4000 Floors 3 & 4 4100 Carillon Pt. Kirkland, WA 98033

DESIGN JPC
DRAWN AN/CB
CHECKED AN
NO. 13-0503



09.30.13 Progress Set

10.09.13 Permit / Bid Issue

10.22.13 ASI #1

2 11.25.13 ASI #2

3 12.17.13 CD Issue

4 12.20.13 ASI #3

5 01.09.14 ASI #4

6 01.29.14 ASI #5

10.09.14 Permit Revision

Demolition Plan - 4th Floor

I-1.4

. ...



09.30.13 Progress Set

10.09.13 Permit / Bid Issue

10.22.13 ASI #1

2 11.25.13 ASI #2

3 12.17.13 CD Issue

4 12.20.13 ASI #3


5 01.09.14 ASI #4

6 01.29.14 ASI #5

10.02.20.14 Permit Revision

Floor Plan - 3rd Floor

I-3.3

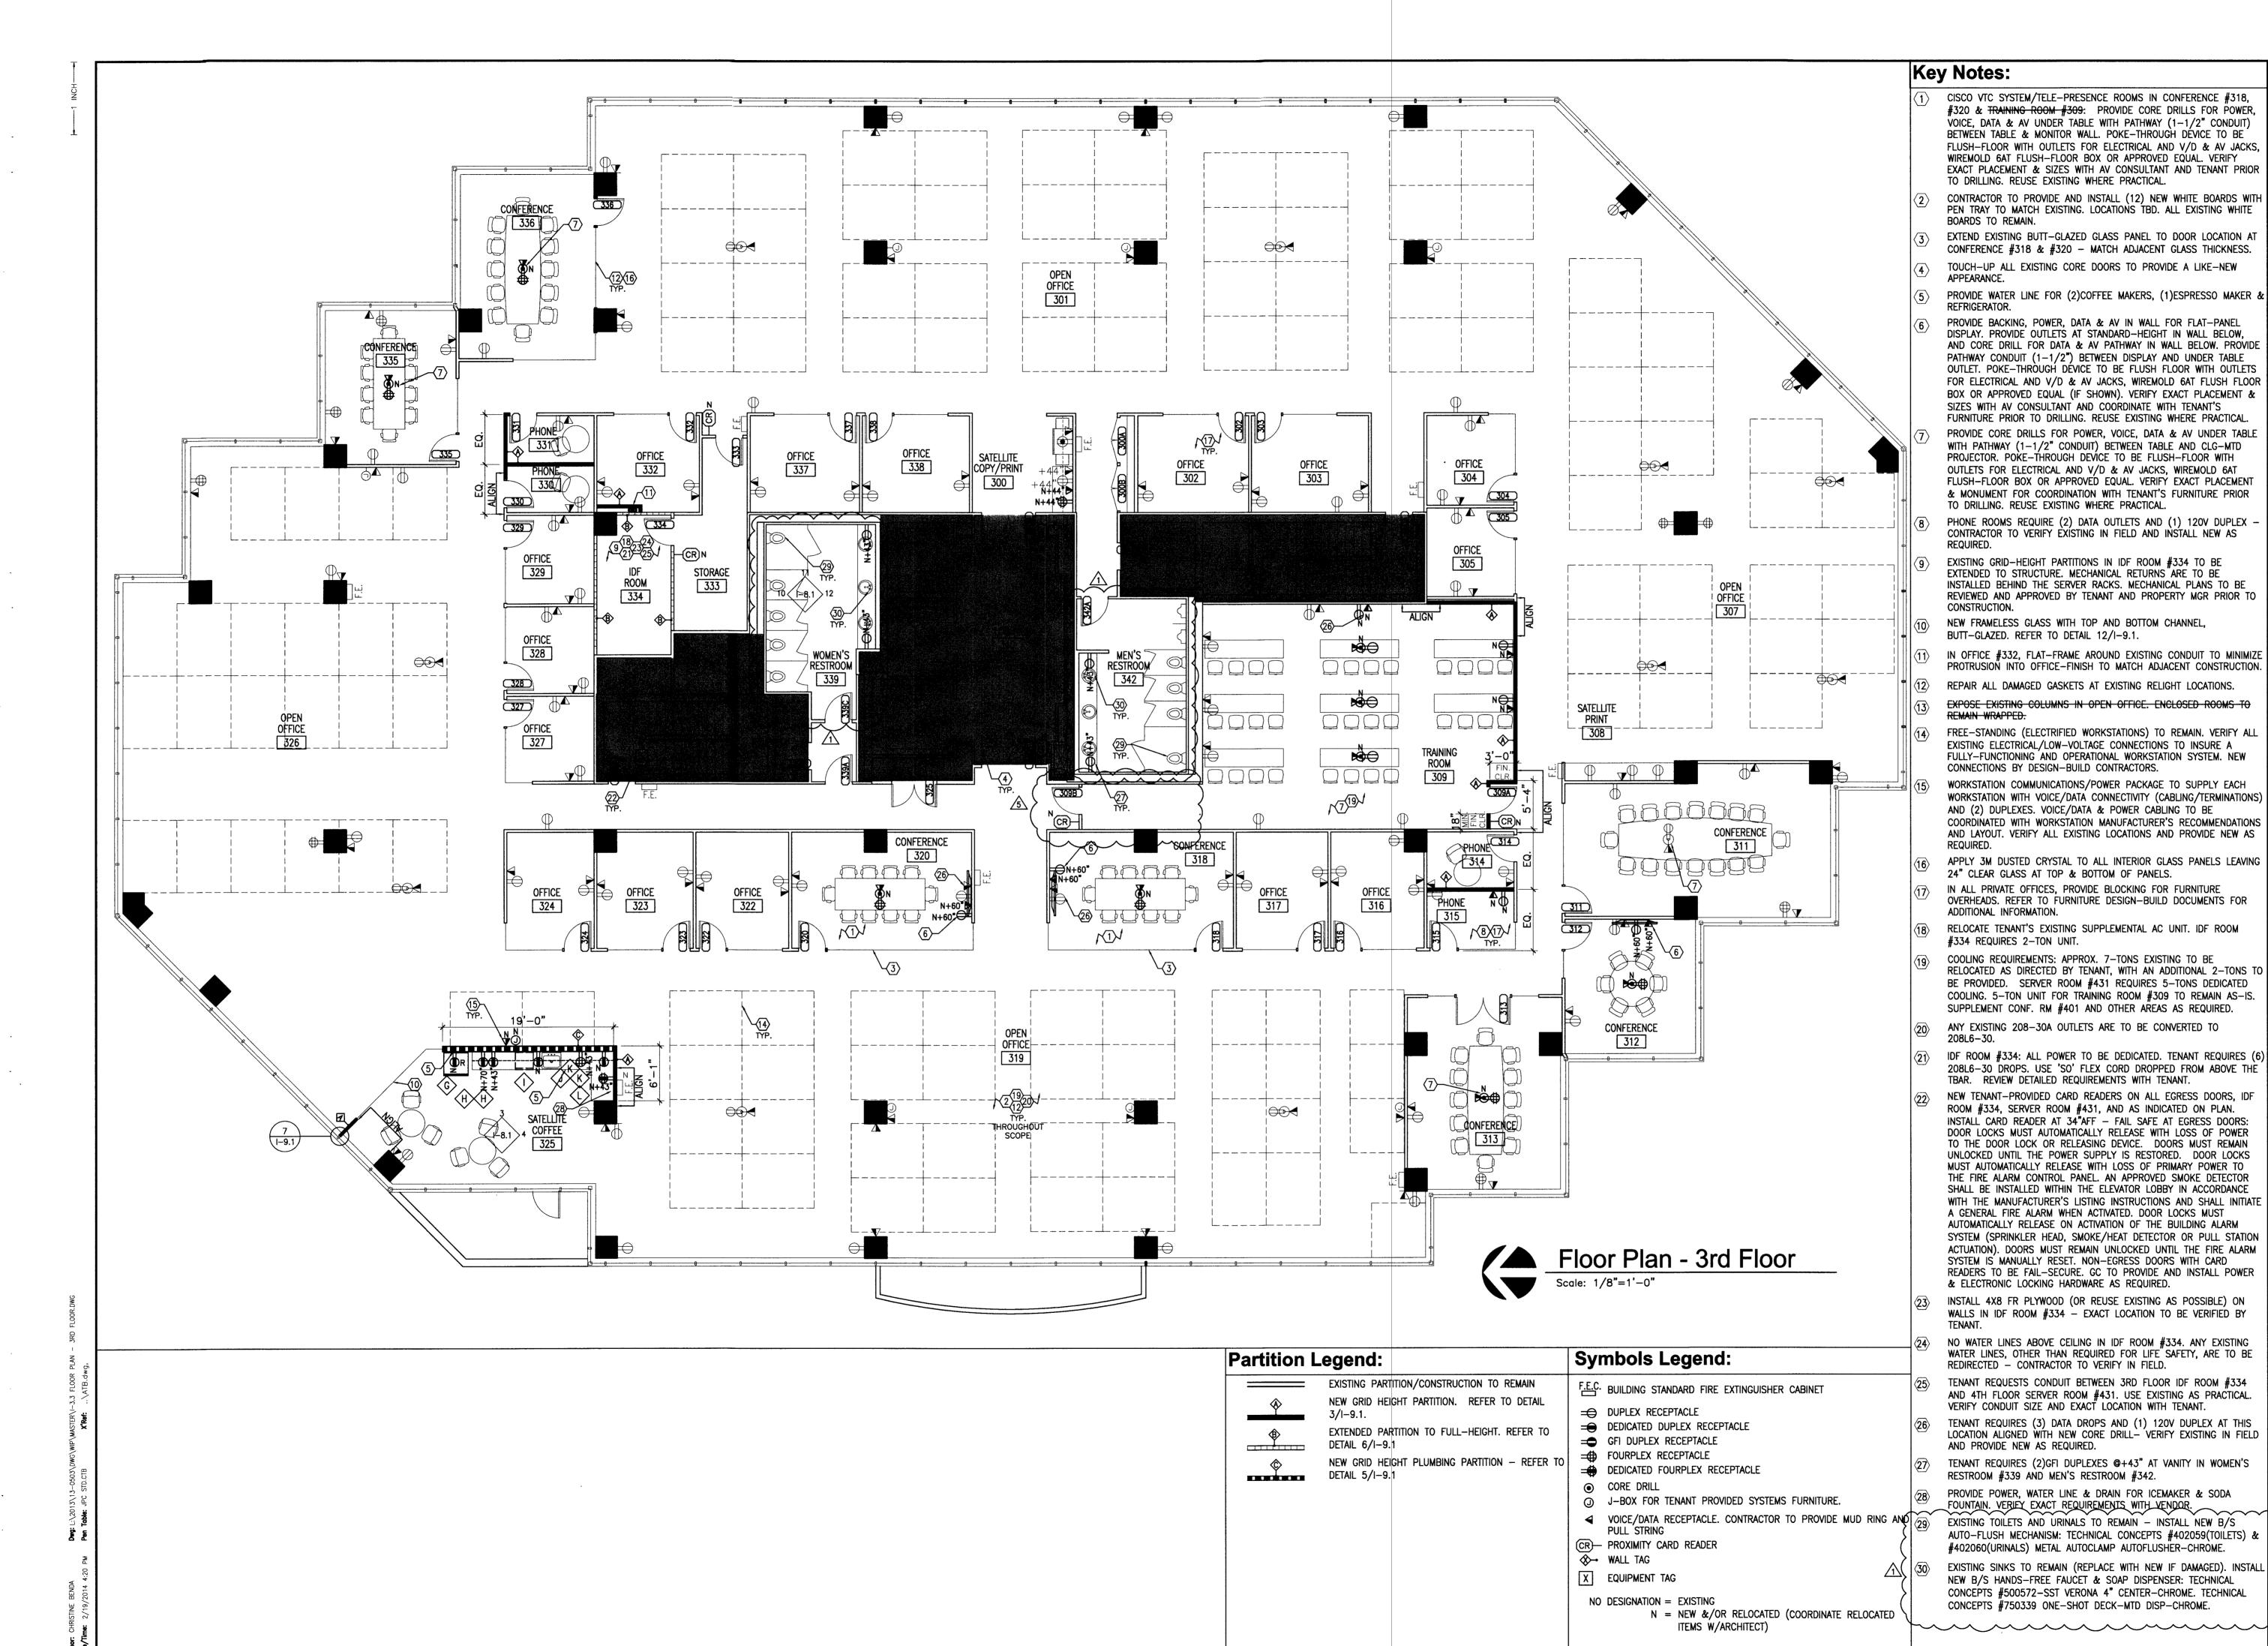


4100 Carillon Pt.

Kirkland, WA 98033

Floor Plan - 4th Floor

I-3.4

© 2013, JPC Architects, PLLC

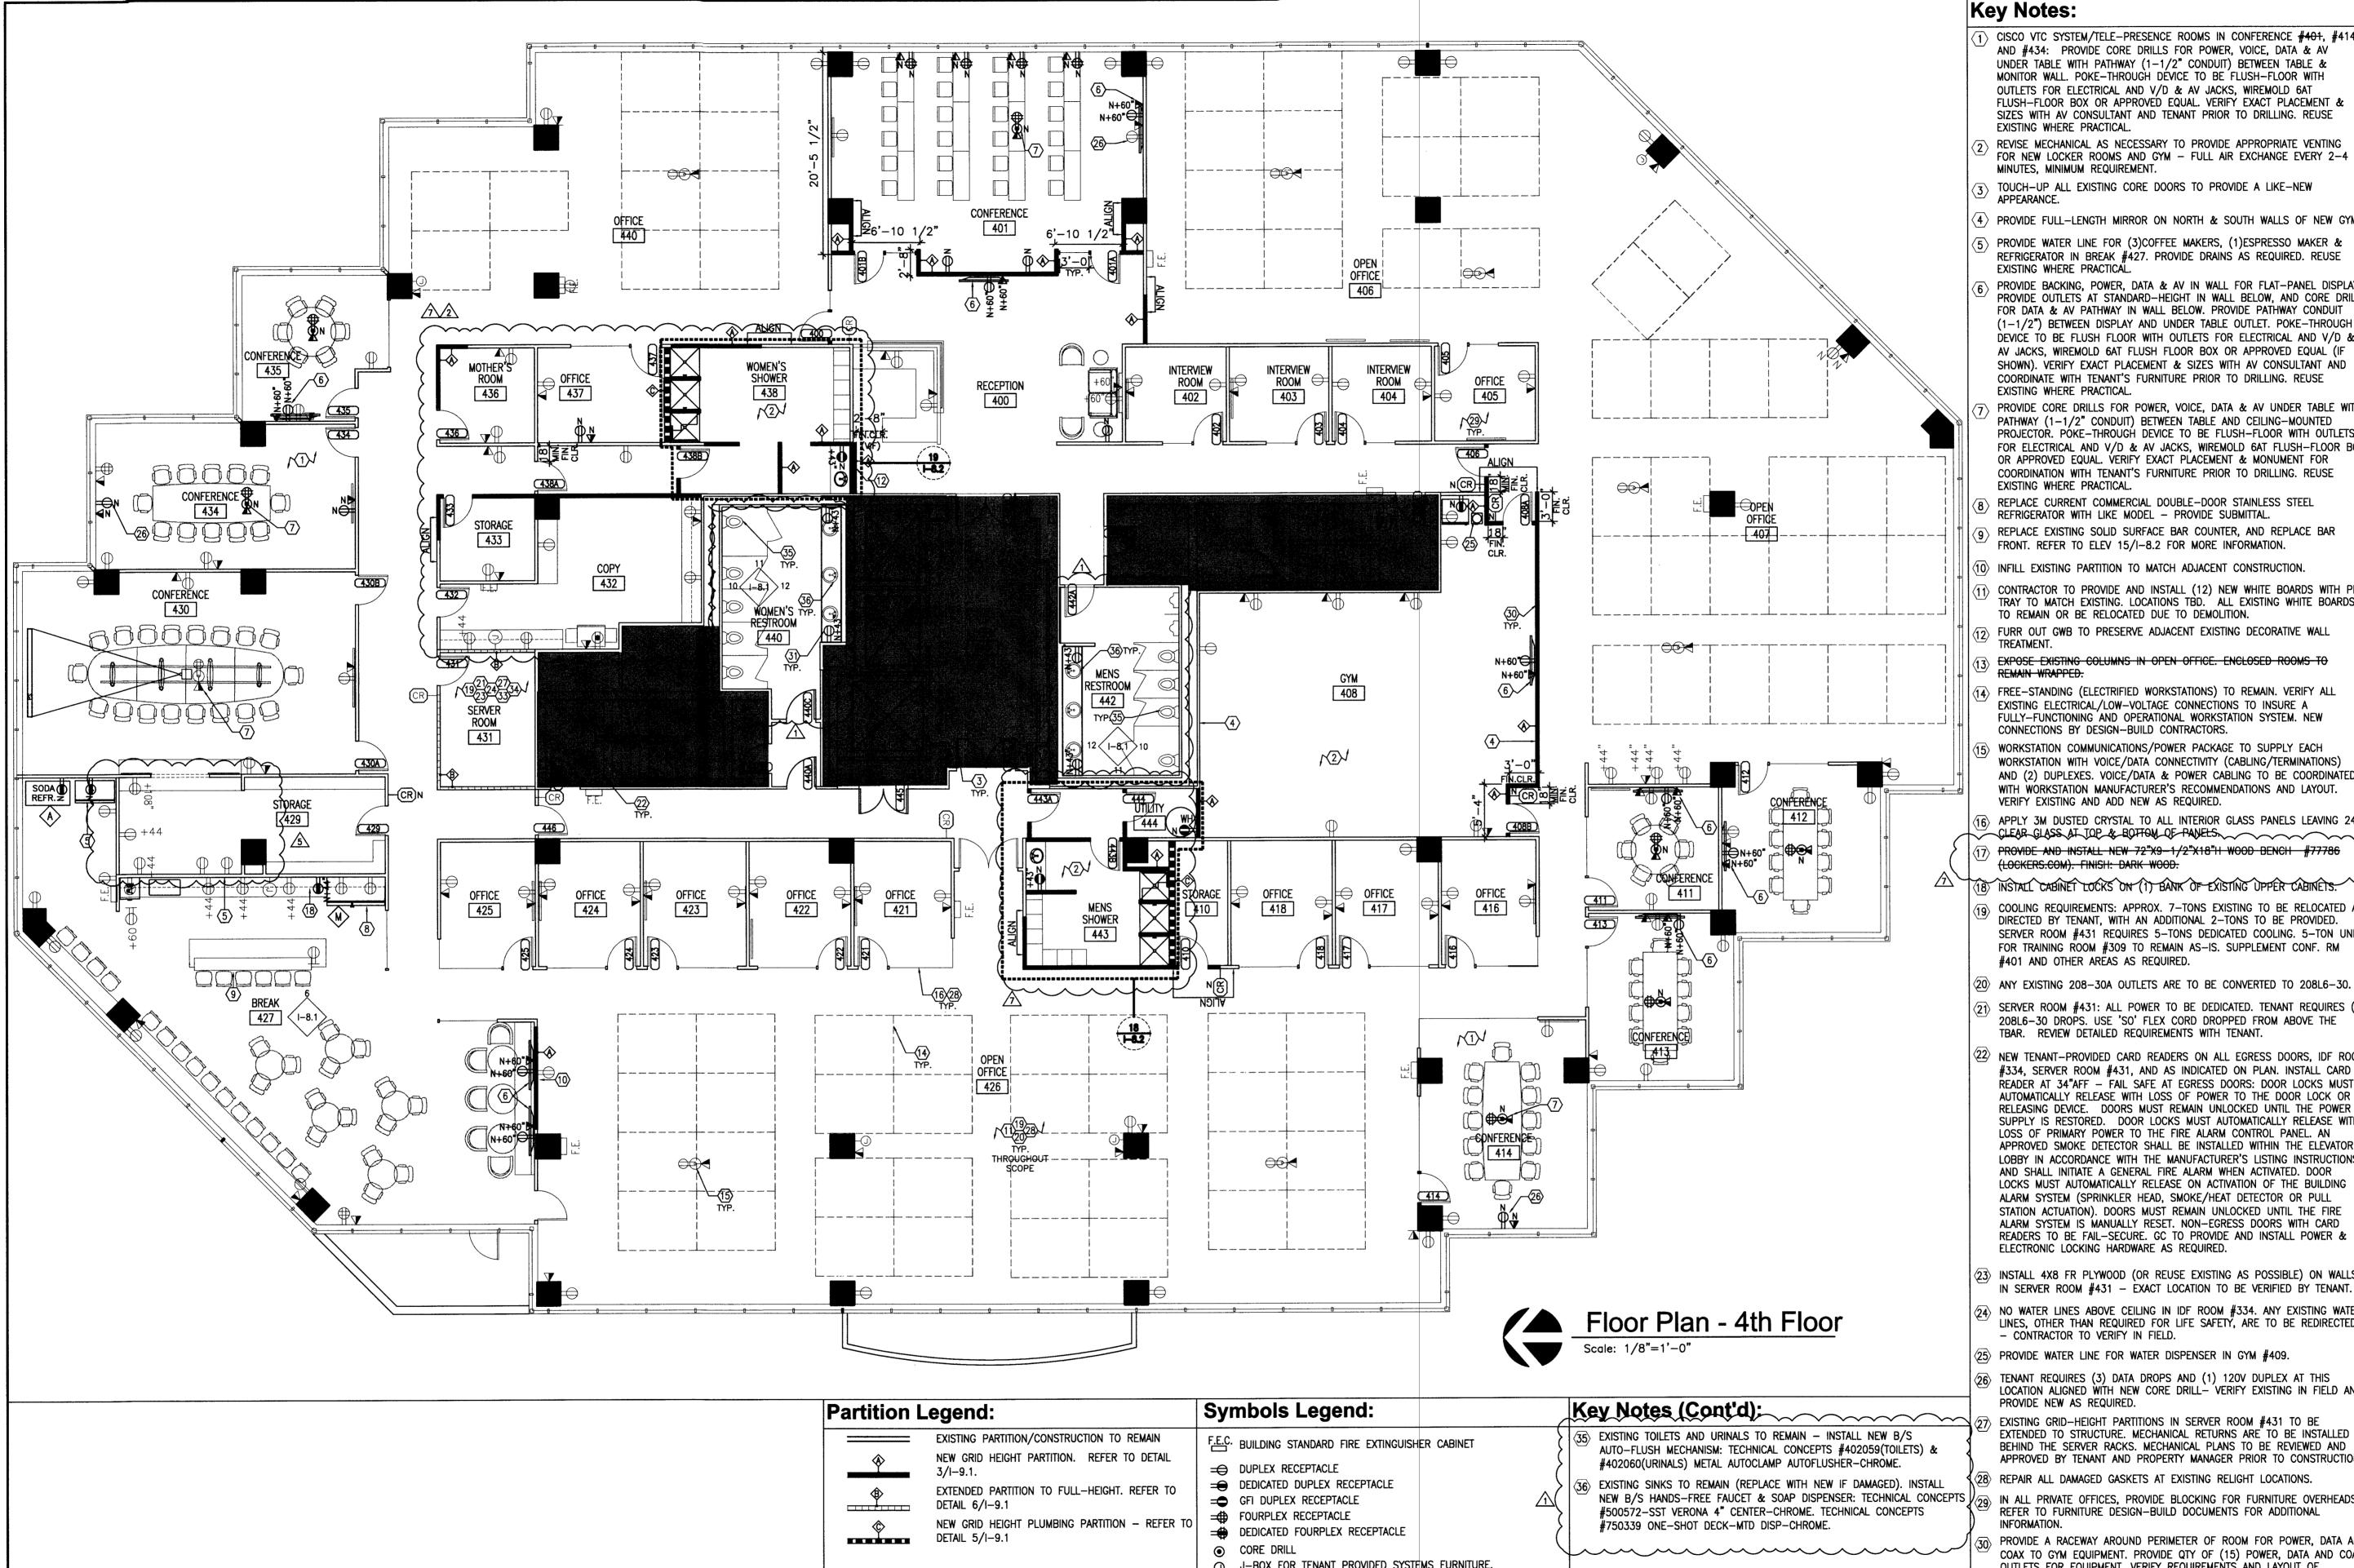

- J-BOX FOR TENANT PROVIDED SYSTEMS FURNITURE.

ITEMS W/ARCHITECT)

- PULL STRING
- CR- PROXIMITY CARD READER
- ♦ WALL TAG
- X EQUIPMENT TAG

NO DESIGNATION = EXISTING N = NEW &/OR RELOCATED (COORDINATE RELOCATED

EQUIPMENT WITH TENANT.

RESTROOM #439 AND MEN'S RESTROOM #442.

(32) NOT USED

(34) PROVIDE 2" CONDUIT BETWEEN MPO AND SERVER ROOM #431 FOR COMCAST CABLING.

SIZES WITH AV CONSULTANT AND TENANT PRIOR TO DRILLING. REUSE EXISTING WHERE PRACTICAL. REVISE MECHANICAL AS NECESSARY TO PROVIDE APPROPRIATE VENTING

FOR NEW LOCKER ROOMS AND GYM - FULL AIR EXCHANGE EVERY 2-4 MINUTES, MINIMUM REQUIREMENT.

TOUCH-UP ALL EXISTING CORE DOORS TO PROVIDE A LIKE-NEW APPEARANCE.

 \langle 4angle provide full—length mirror on north & south walls of New Gym.

5> PROVIDE WATER LINE FOR (3)COFFEE MAKERS, (1)ESPRESSO MAKER & REFRIGERATOR IN BREAK #427. PROVIDE DRAINS AS REQUIRED. REUSE EXISTING WHERE PRACTICAL.

PROVIDE BACKING, POWER, DATA & AV IN WALL FOR FLAT—PANEL DISPLAY PROVIDE OUTLETS AT STANDARD-HEIGHT IN WALL BELOW, AND CORE DRILL FOR DATA & AV PATHWAY IN WALL BELOW. PROVIDE PATHWAY CONDUIT (1-1/2") BETWEEN DISPLAY AND UNDER TABLE OUTLET. POKE-THROUGH DEVICE TO BE FLUSH FLOOR WITH OUTLETS FOR ELECTRICAL AND V/D & AV JACKS, WIREMOLD 6AT FLUSH FLOOR BOX OR APPROVED EQUAL (IF SHOWN). VERIFY EXACT PLACEMENT & SIZES WITH AV CONSULTANT AND COORDINATE WITH TENANT'S FURNITURE PRIOR TO DRILLING. REUSE EXISTING WHERE PRACTICAL.

PROVIDE CORE DRILLS FOR POWER, VOICE, DATA & AV UNDER TABLE WITH PATHWAY (1-1/2" CONDUIT) BETWEEN TABLE AND CEILING-MOUNTED PROJECTOR. POKE-THROUGH DEVICE TO BE FLUSH-FLOOR WITH OUTLETS FOR ELECTRICAL AND V/D & AV JACKS, WIREMOLD 6AT FLUSH-FLOOR BOX OR APPROVED EQUAL. VERIFY EXACT PLACEMENT & MONUMENT FOR COORDINATION WITH TENANT'S FURNITURE PRIOR TO DRILLING. REUSE EXISTING WHERE PRACTICAL.

REPLACE CURRENT COMMERCIAL DOUBLE-DOOR STAINLESS STEEL REFRIGERATOR WITH LIKE MODEL - PROVIDE SUBMITTAL.

REPLACE EXISTING SOLID SURFACE BAR COUNTER, AND REPLACE BAR FRONT. REFER TO ELEV 15/I-8.2 FOR MORE INFORMATION.

10) INFILL EXISTING PARTITION TO MATCH ADJACENT CONSTRUCTION.

CONTRACTOR TO PROVIDE AND INSTALL (12) NEW WHITE BOARDS WITH PEN TRAY TO MATCH EXISTING. LOCATIONS TBD. ALL EXISTING WHITE BOARDS TO REMAIN OR BE RELOCATED DUE TO DEMOLITION.

FURR OUT GWB TO PRESERVE ADJACENT EXISTING DECORATIVE WALL TREATMENT.

EXPOSE EXISTING COLUMNS IN OPEN OFFICE. ENCLOSED ROOMS TO

FREE-STANDING (ELECTRIFIED WORKSTATIONS) TO REMAIN. VERIFY ALL EXISTING ELECTRICAL/LOW-VOLTAGE CONNECTIONS TO INSURE A FULLY-FUNCTIONING AND OPERATIONAL WORKSTATION SYSTEM. NEW CONNECTIONS BY DESIGN-BUILD CONTRACTORS.

WORKSTATION COMMUNICATIONS/POWER PACKAGE TO SUPPLY EACH WORKSTATION WITH VOICE/DATA CONNECTIVITY (CABLING/TERMINATIONS) AND (2) DUPLEXES. VOICE/DATA & POWER CABLING TO BE COORDINATED WITH WORKSTATION MANUFACTURER'S RECOMMENDATIONS AND LAYOUT. VERIFY EXISTING AND ADD NEW AS REQUIRED.

 $_{16}
angle$ apply 3M dusted crystal to all interior glass panels leaving 24' CLEAR GLASS AT TOP & BOTTON OF PANELS.

77 PROVIDE AND INSTALL NEW 72"X9-1/2"X18"H WOOD BENCH #77786 (LOCKERS.COM). FINISH: DARK WOOD.

(18) INSTALL CABINET LOCKS ON (1) BANK OF EXISTING UPPER CABINETS.

COOLING REQUIREMENTS: APPROX. 7-TONS EXISTING TO BE RELOCATED A DIRECTED BY TENANT, WITH AN ADDITIONAL 2-TONS TO BE PROVIDED. SERVER ROOM #431 REQUIRES 5-TONS DEDICATED COOLING. 5-TON UNIT FOR TRAINING ROOM #309 TO REMAIN AS-IS. SUPPLEMENT CONF. RM #401 AND OTHER AREAS AS REQUIRED.

(20) ANY EXISTING 208-30A OUTLETS ARE TO BE CONVERTED TO 208L6-30.

(21) SERVER ROOM #431: ALL POWER TO BE DEDICATED. TENANT REQUIRES (208L6-30 DROPS. USE 'SO' FLEX CORD DROPPED FROM ABOVE THE TBAR. REVIEW DETAILED REQUIREMENTS WITH TENANT.

(22) NEW TENANT-PROVIDED CARD READERS ON ALL EGRESS DOORS, IDF ROOM #334, SERVER ROOM #431, AND AS INDICATED ON PLAN. INSTALL CARD READER AT 34"AFF - FAIL SAFE AT EGRESS DOORS: DOOR LOCKS MUST AUTOMATICALLY RELEASE WITH LOSS OF POWER TO THE DOOR LOCK OR RELEASING DEVICE. DOORS MUST REMAIN UNLOCKED UNTIL THE POWER SUPPLY IS RESTORED. DOOR LOCKS MUST AUTOMATICALLY RELEASE WITH LOSS OF PRIMARY POWER TO THE FIRE ALARM CONTROL PANEL. AN APPROVED SMOKE DETECTOR SHALL BE INSTALLED WITHIN THE ELEVATOR LOBBY IN ACCORDANCE WITH THE MANUFACTURER'S LISTING INSTRUCTIONS AND SHALL INITIATE A GENERAL FIRE ALARM WHEN ACTIVATED. DOOR LOCKS MUST AUTOMATICALLY RELEASE ON ACTIVATION OF THE BUILDING ALARM SYSTEM (SPRINKLER HEAD, SMOKE/HEAT DETECTOR OR PULL STATION ACTUATION). DOORS MUST REMAIN UNLOCKED UNTIL THE FIRE ALARM SYSTEM IS MANUALLY RESET. NON-EGRESS DOORS WITH CARD READERS TO BE FAIL-SECURE. GC TO PROVIDE AND INSTALL POWER & ELECTRONIC LOCKING HARDWARE AS REQUIRED.

(23) INSTALL 4X8 FR PLYWOOD (OR REUSE EXISTING AS POSSIBLE) ON WALLS IN SERVER ROOM #431 - EXACT LOCATION TO BE VERIFIED BY TENANT.

 $\overline{m{\phi_4}}$ no water lines above ceiling in IDF room #334. Any existing water LINES, OTHER THAN REQUIRED FOR LIFE SAFETY, ARE TO BE REDIRECTED

- CONTRACTOR TO VERIFY IN FIELD. 25) PROVIDE WATER LINE FOR WATER DISPENSER IN GYM #409.

(26) TENANT REQUIRES (3) DATA DROPS AND (1) 120V DUPLEX AT THIS LOCATION ALIGNED WITH NEW CORE DRILL- VERIFY EXISTING IN FIELD AND PROVIDE NEW AS REQUIRED.

(27) EXISTING GRID—HEIGHT PARTITIONS IN SERVER ROOM #431 TO BE EXTENDED TO STRUCTURE. MECHANICAL RETURNS ARE TO BE INSTALLED BEHIND THE SERVER RACKS. MECHANICAL PLANS TO BE REVIEWED AND APPROVED BY TENANT AND PROPERTY MANAGER PRIOR TO CONSTRUCTION

8) REPAIR ALL DAMAGED GASKETS AT EXISTING RELIGHT LOCATIONS.

IN ALL PRIVATE OFFICES, PROVIDE BLOCKING FOR FURNITURE OVERHEADS. REFER TO FURNITURE DESIGN-BUILD DOCUMENTS FOR ADDITIONAL

PROVIDE A RACEWAY AROUND PERIMETER OF ROOM FOR POWER, DATA AND COAX TO GYM EQUIPMENT. PROVIDE QTY OF (15) POWER, DATA AND COAX OUTLETS FOR EQUIPMENT. VERIFY REQUIREMENTS AND LAYOUT OF

(31) TENANT REQUIRES (2)GFI DUPLEXES @+43" AT VANITY IN WOMEN'S

(33) TENANT REQUESTS CONDUIT BETWEEN 3RD FLOOR IDF ROOM #334 AND 4TH FLOOR SERVER ROOM #431. USE EXISTING AS PRACTICAL. VERIFY CONDUIT SIZE AND EXACT LOCATION WITH TENANT.


Carillon Point B4000



09.30.13	Progress Set
10.09.13	Permit / Bid Issue
10.22.13	ASI #1
11.25.13	ASI #2
3 12.17.13	CD Issue
12.20.13	ASI #3
5 01.09.14	ASI #4
6 01.29.14	ASI #5
<u>/</u> 7\02.20.14	Permit Revision

Demo Reflected Ceiling Plan - 3rd Floor

I-4.3.1

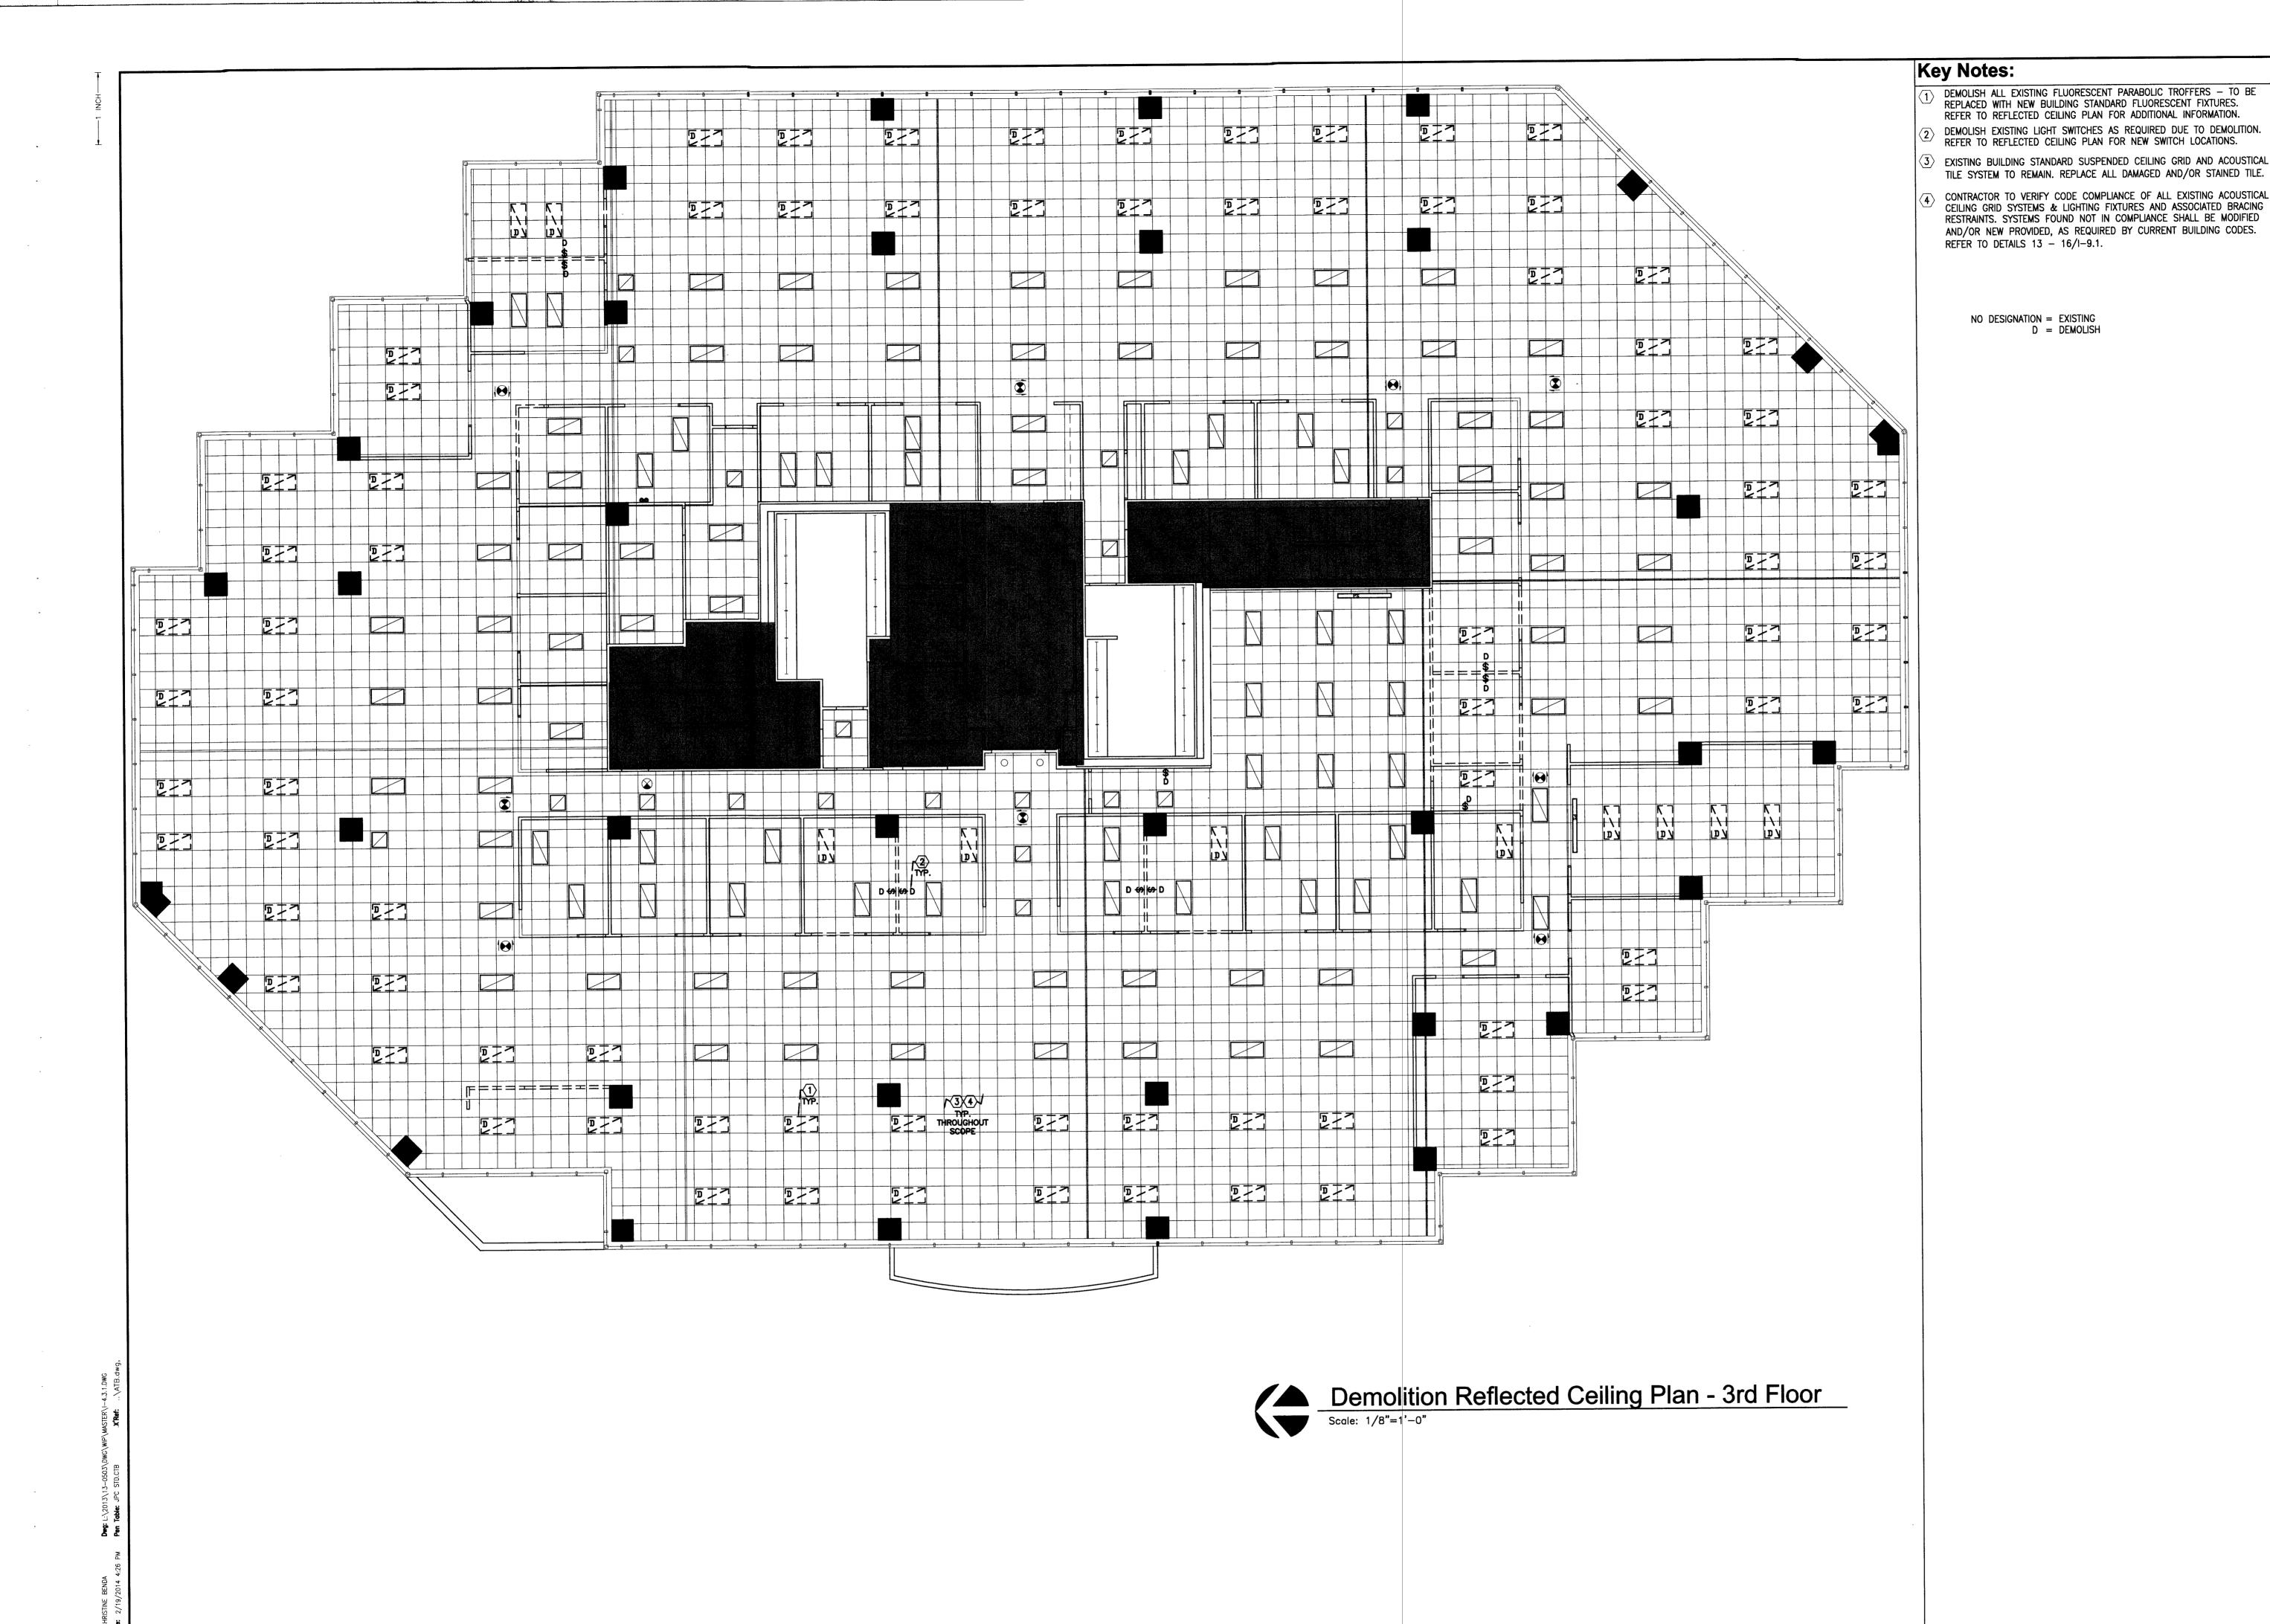

MFG.

NULITE

LIGHTOLIER

ECOSENSE

KOVACS

NO DESIGNATION = EXISTING

ITEMS W/ARCHITECT)

\$3

F-6

F-7

DESCRIPTION

SWITCH

3WAY SWITCH

LIGHT FIXTURE

2-T8 WW LAMPS

QUAD LAMPS

#NU-24-120.

FOCAL POINT | BLDG STD 2x4 FLU. LIGHT

BLDG STD EXIT LIGHT

EXTG BLDG STD 2x4 SUSP. CEILING GRID & TILE

EXTG BLDG STD FLU. STRIP

FIXTURE: LUNA #FLU24B

BLDG STD RECESSED, FLU.

DOWNLIGHT FIXTURE, 2-13W

FLU. UNDER-CABINET LIGHTING.

PROVIDE SWITCH AT COUNTER. 6"D FLUOR. DOWNLIGHT FOR WET

CALCULITE CFL LENSED DOWNLIGH

#8091FCLW, OR APPROVED EQUAI

#04LC-XX-3500K-120-120,

VERIFY EXACT LOCATION WITH

JENANT'S ALV VENDOR

WALL SCONCE #P5040-37B.

DIMS: 4.75"Wx13.25"Hx4"PROJ.

FINISH: DARK RESTORATION

GLASS: ETCHED OPAL.

LAMPS: 2-40W XENON

BRONZE.

N = NEW &/OR RELOCATED (COORDINATE RELOCATED

OR APPROVED EQUAL
CEILING-MOUNTED PROJECTOR -

APPLICATION - LIGHTOLIER

ECOSPEC LINEAR INT


DESIGN DRAWN CHECKED NO.

AN

09.30.13 Progress Set 10.09.13 Permit / Bid Issue /1\ 10.22.13 ASI #1 2 11.25.13 ASI #2 3 12.17.13 CD Issue 4 12.20.13 ASI #3 <u>∕</u>5 01.09.14 ASI #4 6 01.29.14 ASI #5 7\02.20.14 Permit Revision

Reflected Ceiling Plan - 3rd Floor

I-4.3.2

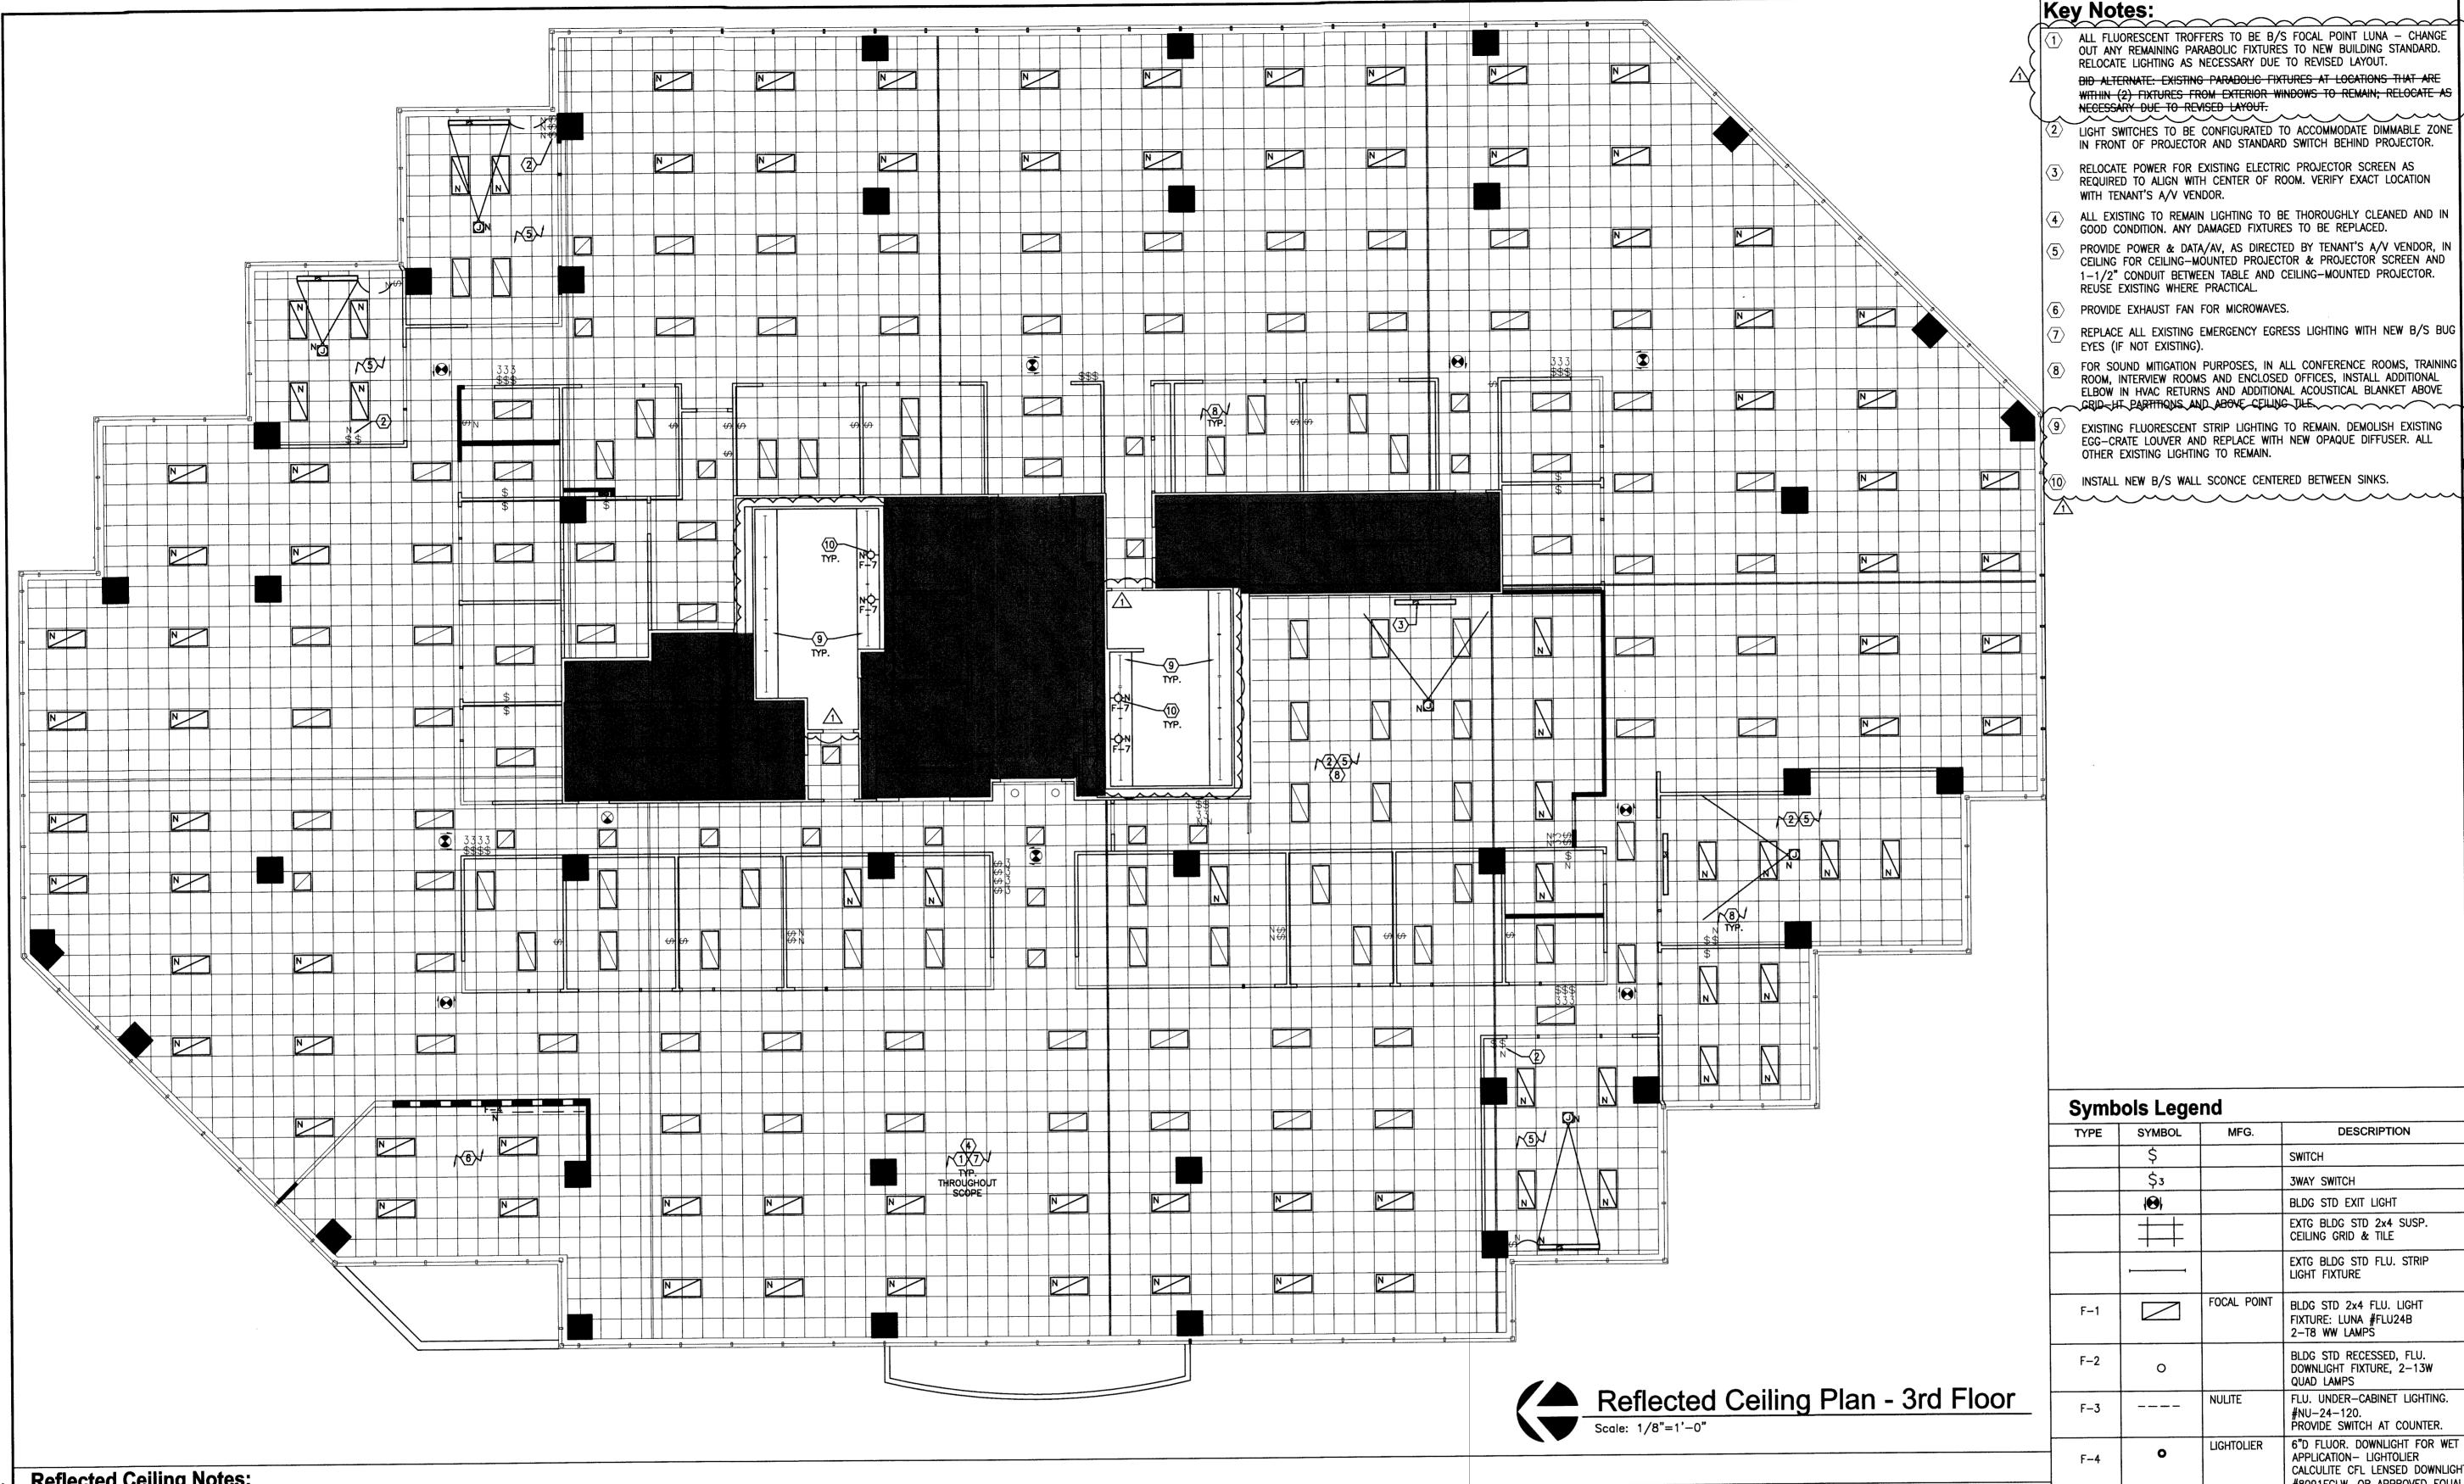

Reflected Ceiling Notes:

COORDINATE THE WORK OF ALL TRADES INVOLVED IN THE CEILING WORK TO ENSURE CLEARANCES FOR FIXTURES, DUCTS, PIPING, CEILING SUSPENSION SYSTEM, ETC., NECESSARY TO MAINTAIN THE FINISHED CEILING HEIGHTS INDICATED ON ARCHITECT'S DRAWINGS.

PERIMETER CEILING ANGLE, WHERE OCCURS, SHALL BE INSTALLED TIGHT TO VERTICAL SURFACES, FREE FROM CURVES, BREAKS OR OTHER IRREGULARITIES AND PAINTED TO MATCH CEILING FINISH.

FURNISH AND INSTALL ALL ASSOCIATED TRIM AND SEISMIC BRACING AS REQUIRED.

LIGHT FIXTURES, NEW SPRINKLERS AND OTHER CEILING ELEMENTS SHALL BE CENTERED IN THE 2'X2' SECTION OF INDIVIDUAL CEILING TILES U.N.O. (EXIST. SPRINKLERS TO REMAIN UNLESS CONFLICT WITH NEW ELEMENTS).

PROVIDE CEILING ACCESS AS REQUIRED FOR EQUIPMENT AND SYSTEM MAINTENANCE, AND MATCH ADJACENT CEILING FINISH U.N.O.

ALL SOFFITS AND CEILING HEIGHTS ARE DIMENSIONED FROM TOP OF FINISHED FLOOR TO BOTTOM OF FINISHED GYPSUM BOARD OR CEILING TILE AND SHALL ALLOW FOR THICKNESS OF ALL FLOOR FINISHES.

- THE REFLECTED CEILING PLAN INDICATES THE LOCATION OF CEILING HEIGHTS, LIGHT TYPES, LIGHT FIXTURES, AND ASSOCIATED ITEMS.
- ALL SPECIFIC INFORMATION CONCERNING INSTALLATION FOR VARIOUS ABOVE-CEILING ELEMENTS ARE TO BE DESIGN BUILD, DOCUMENTATION BY OTHERS - PERMITTED SEPARATELY.
- NOTIFY ARCHITECT OF ANY CONFLICTS OF LIGHT FIXTURE LOCATIONS WITH MAIN RUNNERS, DUCTS, STRUCTURES, HVAC, AND/OR (E)CONDUIT, PRIOR TO FRAMING FOR LIGHTS. ANY DISCREPANCIES BETWEEN ARCHITECT'S CEILING GRID LOCATION & ACTUAL FIELD CONDITIONS ARE TO BE CLARIFIED WITH THE ARCHITECT PRIOR TO FRAMING.
- 10. SUBMIT GRILLE, THERMOSTAT, AND OTHER FIXTURE AND ELEMENT LAYOUTS TO THE ARCHITECT FOR REVIEW AT LEAST 2 WEEKS PRIOR TO INSTALLATION.
- 11. VERIFY FIELD CONDITIONS AND LOCATIONS OF ALL PLUMBING, MECHANICAL DUCTS, STRUCTURAL ELEMENTS AND ALL OTHER RELATED ITEMS. INSTALL NEW PLUMBING, MECHANICAL, FANS, DUCTS, CONDUITS, AND OTHER RELATED ITEMS SO AS TO NOT CONFLICT WITH ANY/ALL FIELD CONDITIONS INCLUDING LUMINAIRES.
- 12. INSTALL NEW LIGHT FIXTURES WITH PROTECTIVE FILM OR SIMILAR COVER OVER LOUVER, LENS, BAFFLE, ETC. TO AVOID FIXTURE SOILING OR DAMAGE. FIXTURES SHALL BE MAINTAINED CLEAN AND AS NEW. ALL LAMPS SHALL BE NEW AT PROJECT COMPLETION - RELAMP EXISTING FIXTURES.
- 13. CONTRACTOR TO VERIFY CODE COMPLIANCE OF EXISTING ACOUSTICAL CEILING GRID SYSTEMS AND ASSOCIATED SEISMIC BRACING RESTRAINTS. SYSTEMS FOUND NOT IN COMPLIANCE SHALL BE MODIFIED AND/OR NEW PROVIDED AS REQUIRED BY CURRENT BUILDING CODES (INCLUDING, BUT NOT LIMITED TO; CURRENT IBC WALL MOLDING (2" ANGLE) AND SEISMIC SEPARATION JOINTS).
- 14. CONTRACTOR TO VERIFY CODE COMPLIANCE OF ALL EXISTING LIGHTING FIXTURES AND ASSOCIATED SEISMIC BRACING RESTRAINTS. FIXTURES FOUND NOT IN COMPLIANCE SHALL BE MODIFIED AND/OR NEW PROVIDED AS REQUIRED BY CURRENT BUILDING AND/OR ENERGY COMPLIANCE CODES.
- 15. ALL EXITING LIGHTS AND EGRESS LIGHTING LOCATIONS SHALL BE DETERMINED BY BUILDING AND FIRE INSPECTOR'S FIELD PLACEMENT DETERMINATION.
- FORCE) ISSUE OF THE IBC, IEC AND LOCAL CODES/ORDINANCES. THE ENGINEER MAY USE THE ARCHITECTS EGRESS MAPS (COMMON PATH OF TRAVEL/EXIT TRAVEL DISTANCE) AS STARTING POINT FOR A BASIS OF DESIGN. HOWEVER, IT SHALL REMAIN THE SOLE RESPONSIBILITY OF THE LIGHTING I.E.; ROOMS, SPECIALIZED SPACES, PATHWAYS, ETC. PER THE AFOREMENTIONED CODES. FINAL EGRESS LIGHTING QUANTITIES AND LOCATIONS SHALL BE DETERMINED BY BUILDING AND FIRE INSPECTOR'S FIELD PLACEMENT DETERMINATION.

16. ALL SMOKE DAMPERS SHALL BE INSTALLED IN ACCORDANCE WITH IMC/IBC OR SUPERCEDING CODE. ALL FIRE DAMPERS SHALL BE INSTALLED IN ACCORDANCE WITH IMC/IBC OR SUPERCEDING CODE.

17. EGRESS LIGHTING SHALL BE DESIGNED BY A LICENSED ELECTRICAL ENGINEER BASED ON FINAL FLOOR PLAN(S) AND THE MOST CURRENT (IN ENGINEER TO COMPLETE A SCOPE OF WORK THAT ADDRESSES ALL EGRESS


Floors 3 & 4



09.30.13	Progress Set
10.09.13	Permit / Bid Issue
10.22.13	ASI #1
2 11.25.13	ASI #2
3 12.17.13	CD Issue
<u>4</u> 12.20.13	ASI #3
<u>5</u> 01.09.14	ASI #4
<u>6</u> 01.29.14	ASI #5
<u>^</u> 202.20.14	Permit Revision

Demo Reflected Ceiling Plan - 4th Floor

1-4.4.1

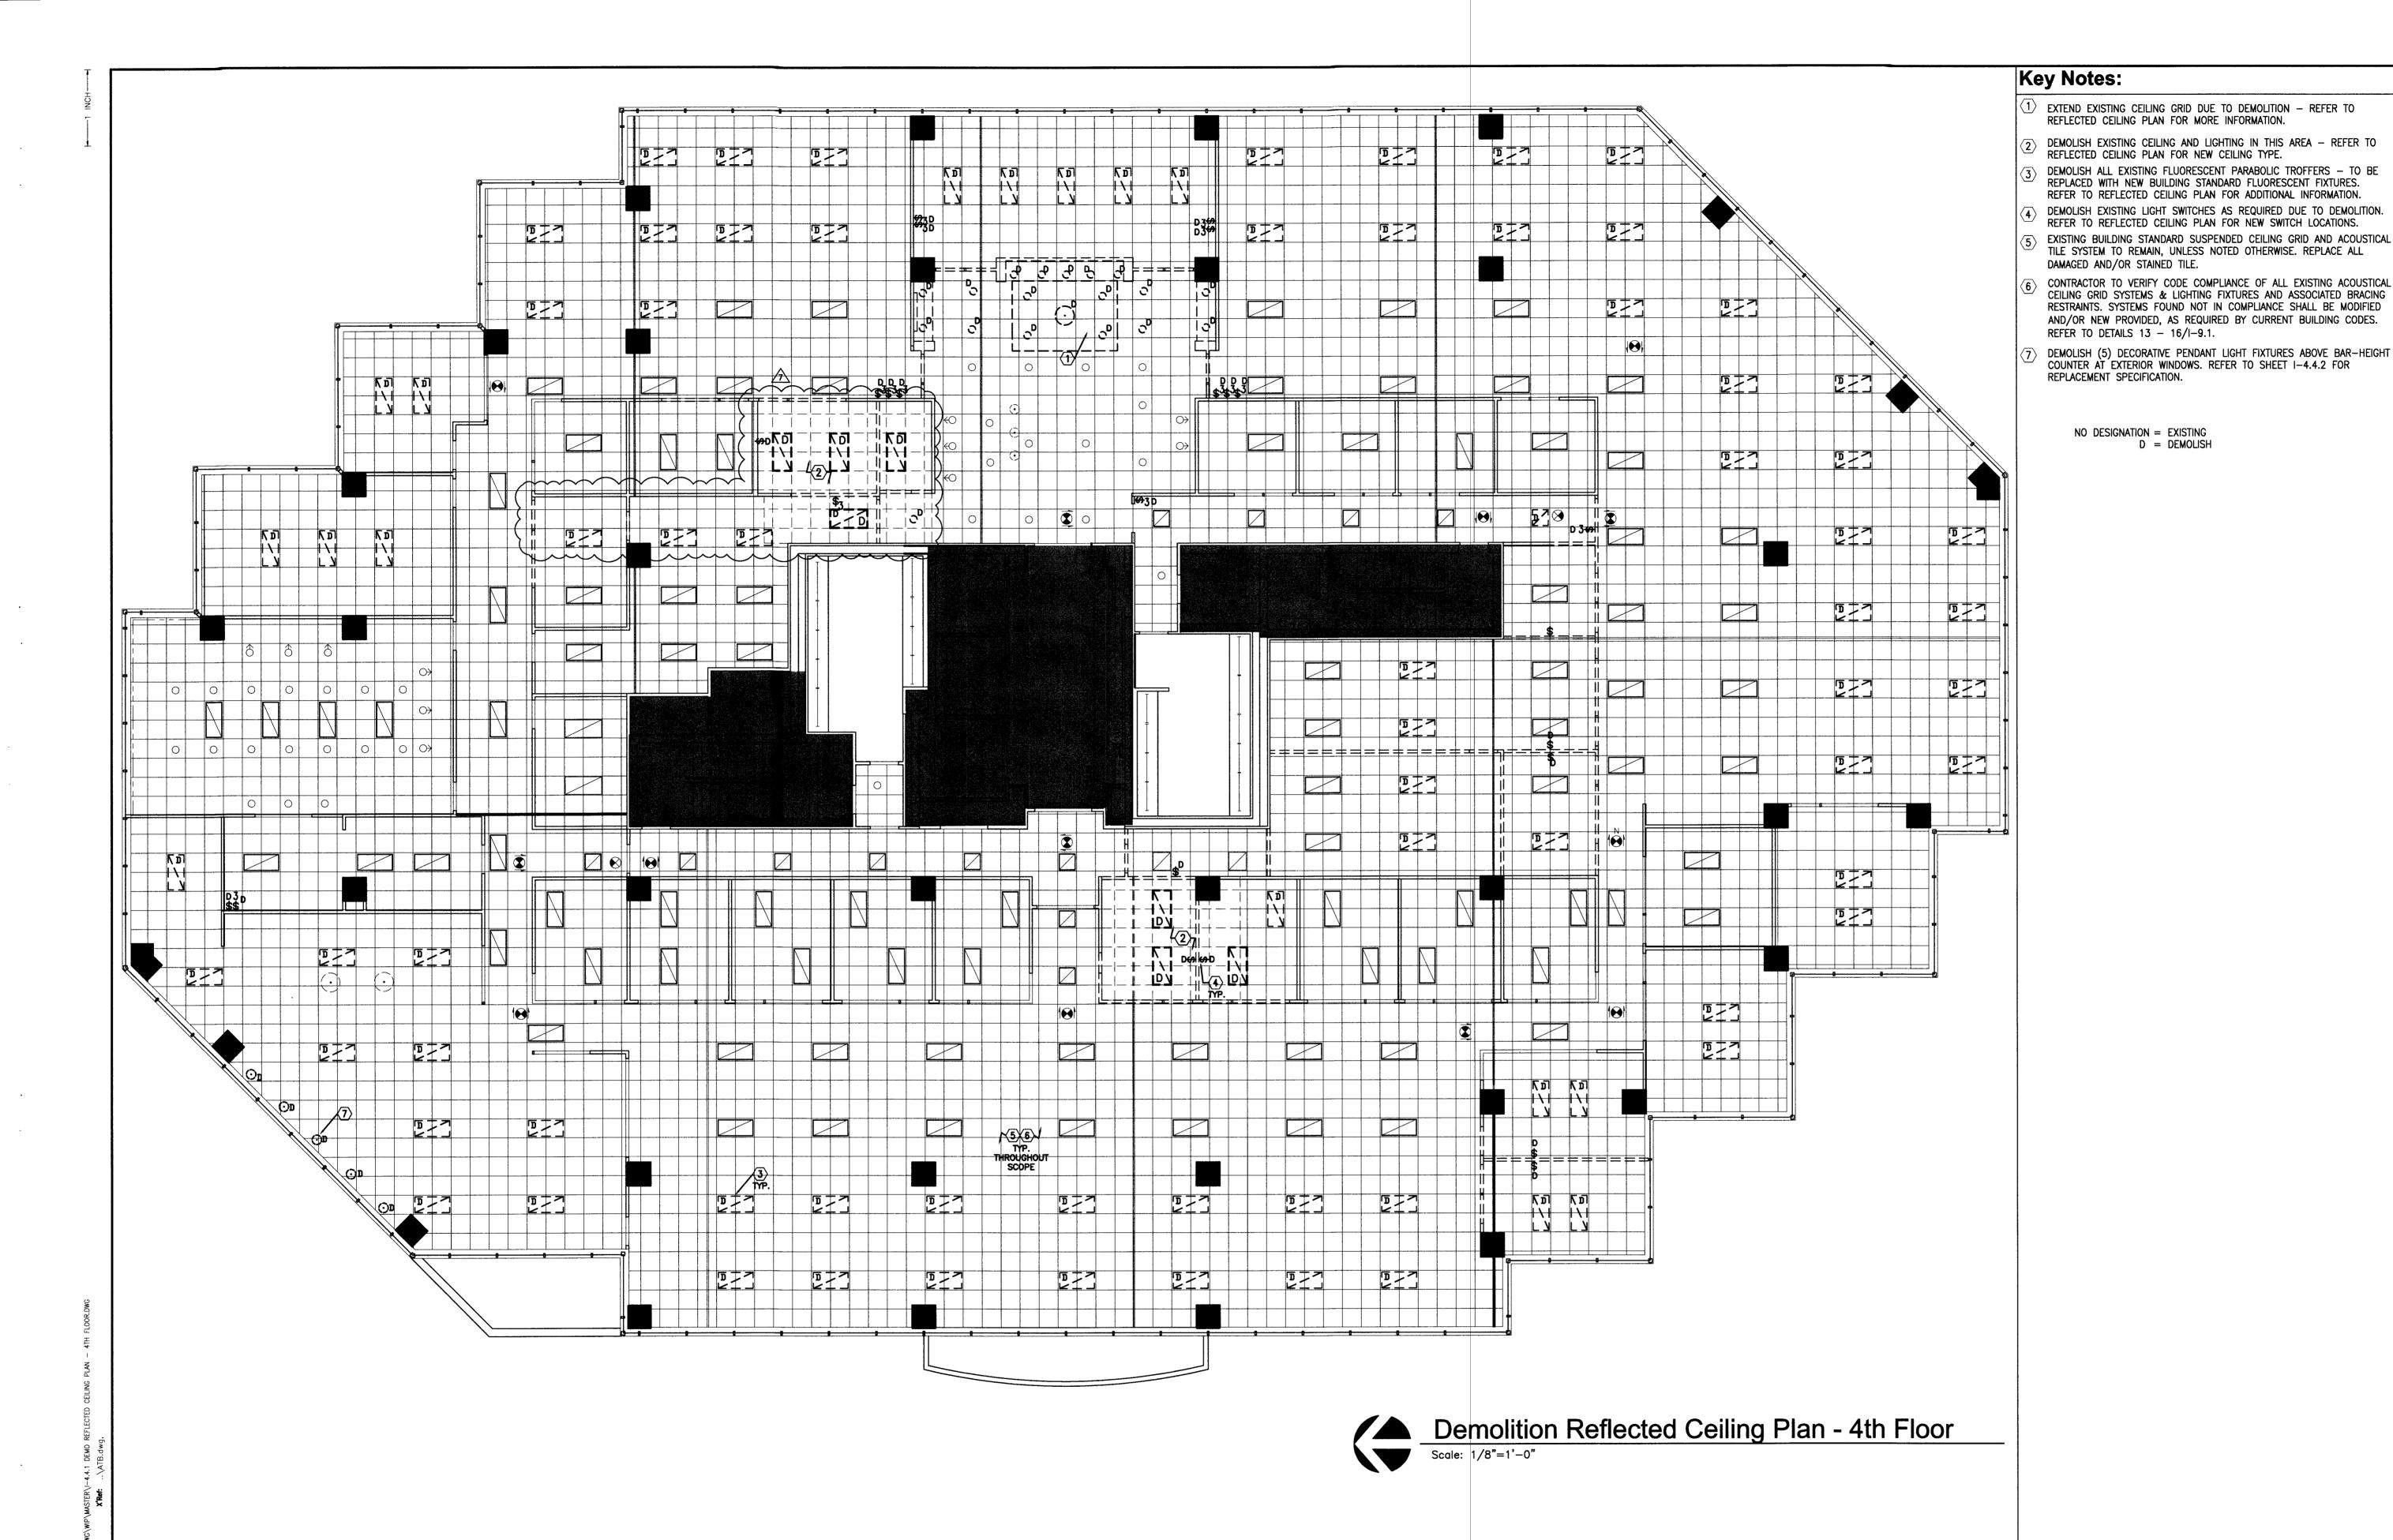


AN

13-0503

Reflected Ceiling Plan - 4th Floor

1-4.4.2

© 2013, JPC Architects, PLLC

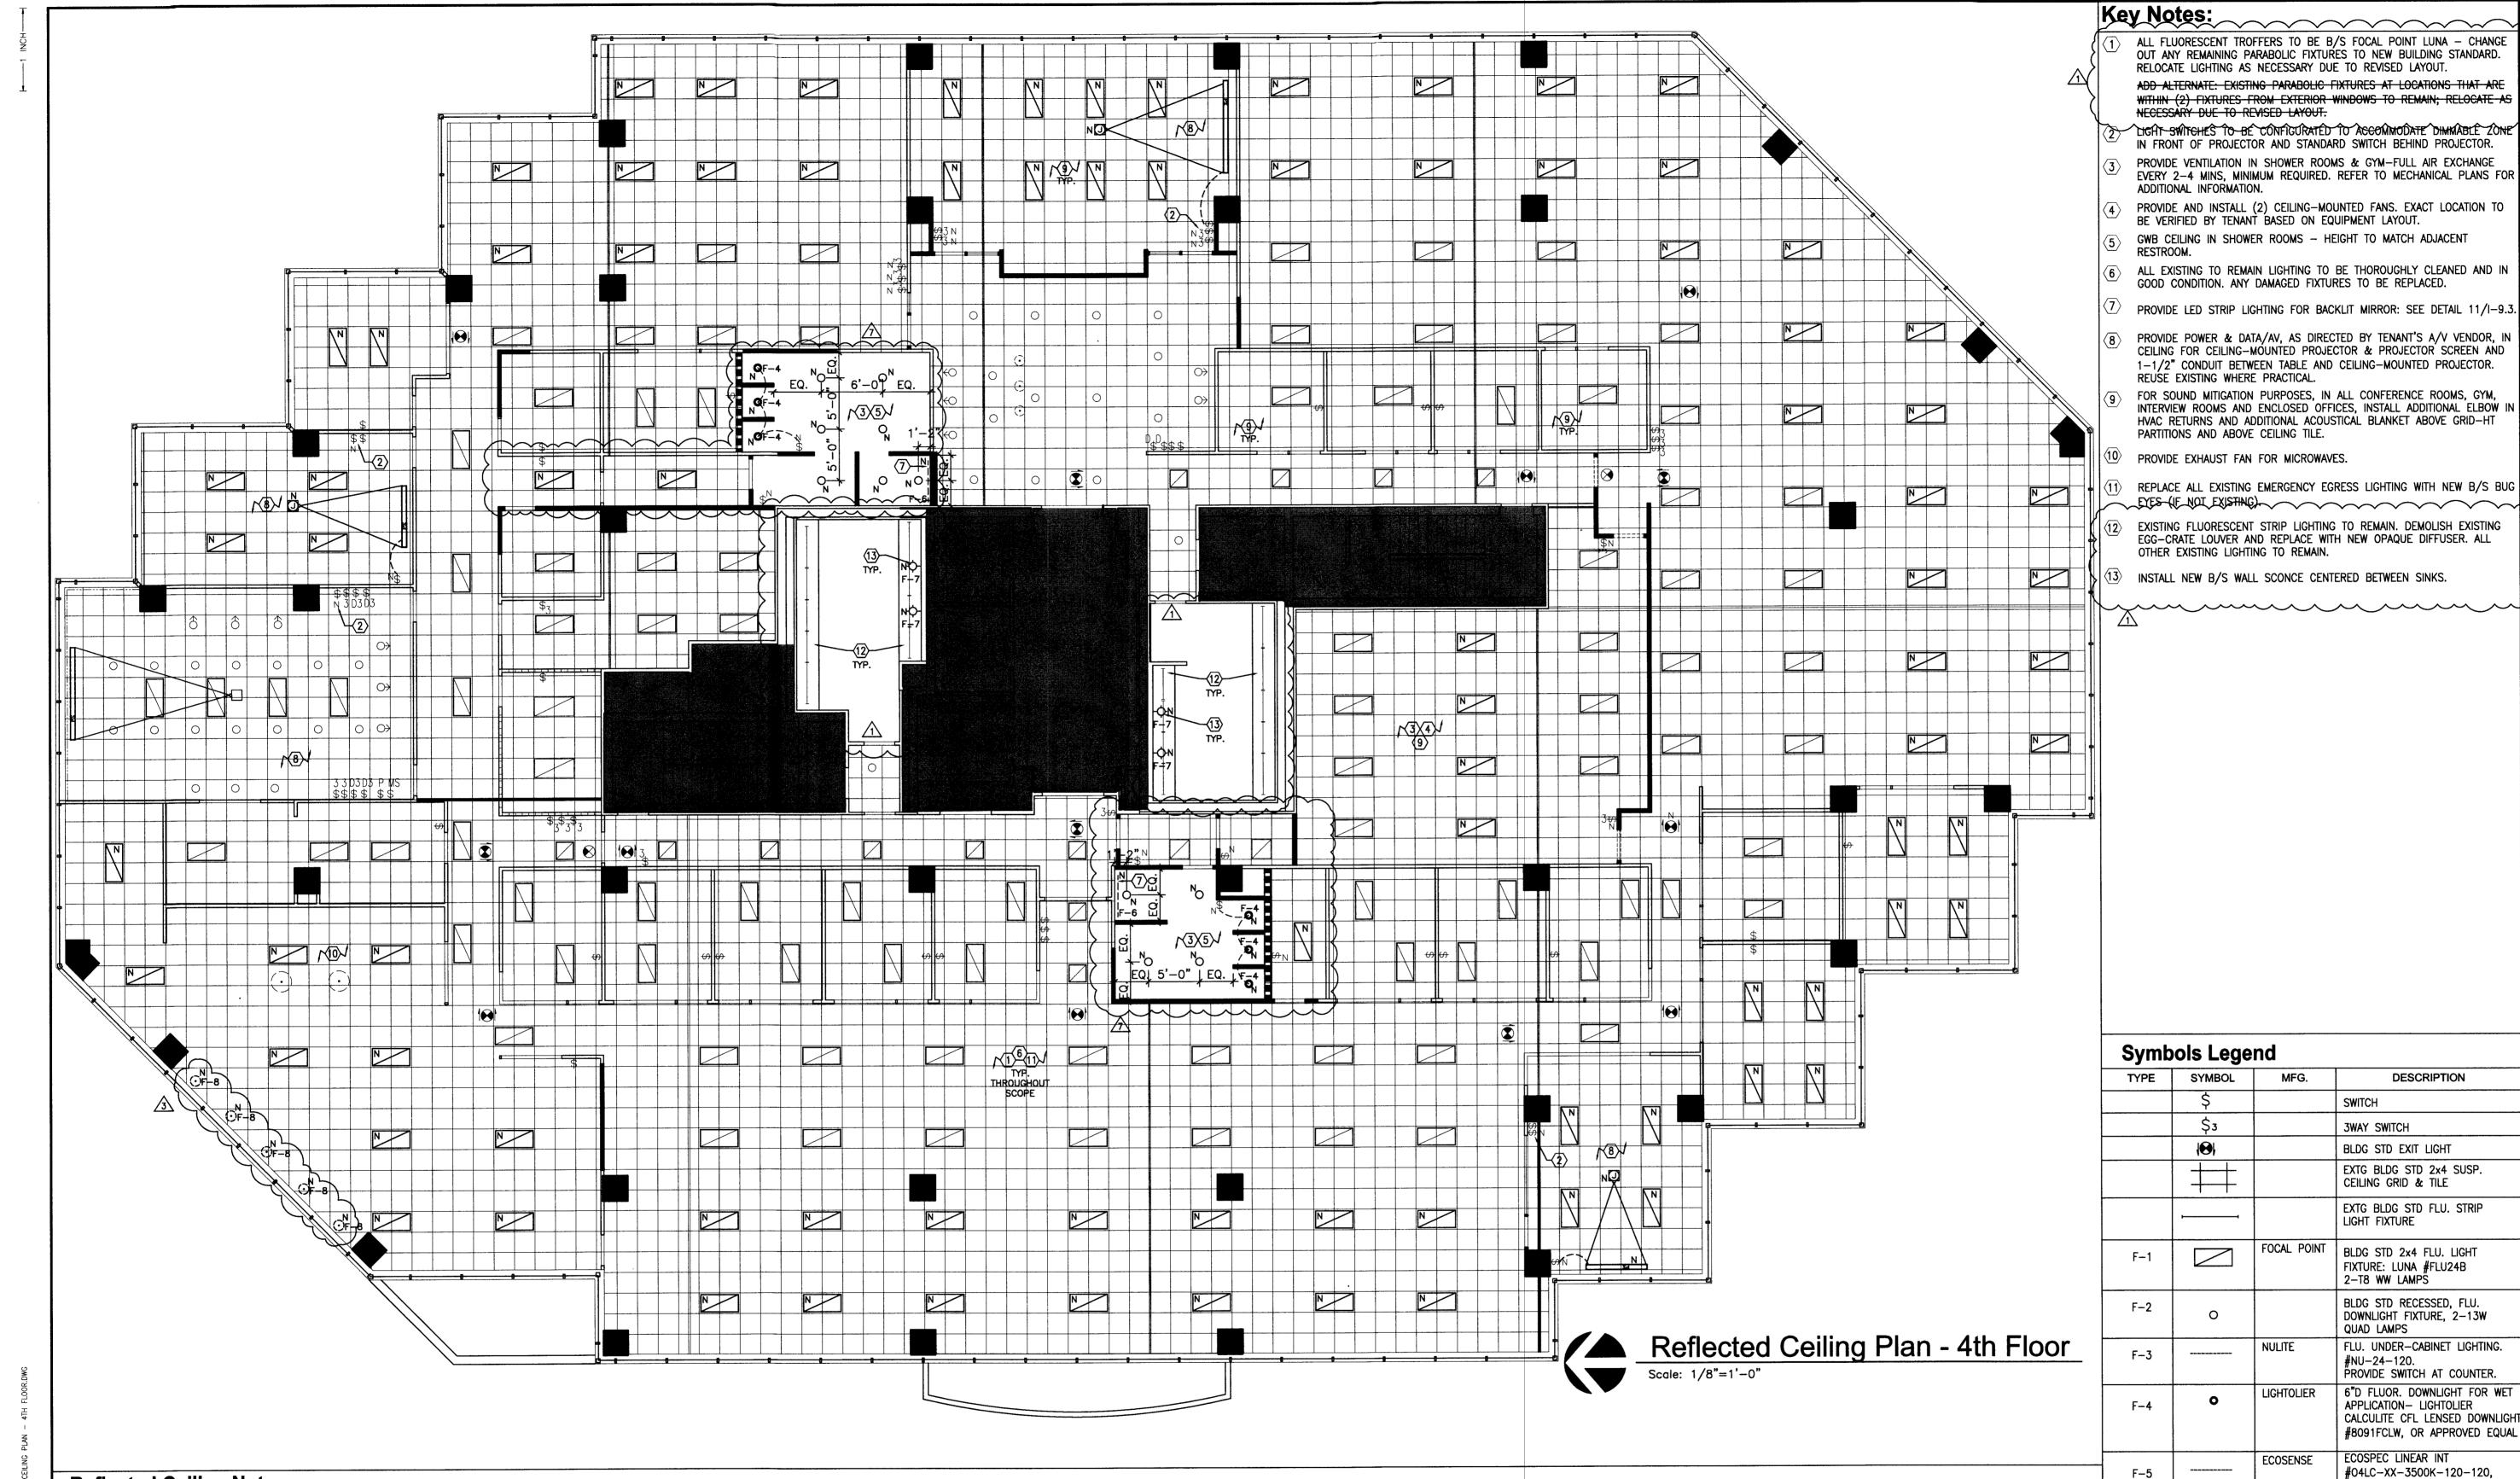

Reflected Ceiling Notes:

COORDINATE THE WORK OF ALL TRADES INVOLVED IN THE CEILING WORK TO ENSURE CLEARANCES FOR FIXTURES, DUCTS, PIPING, CEILING SUSPENSION SYSTEM, ETC., NECESSARY TO MAINTAIN THE FINISHED CEILING HEIGHTS INDICATED ON ARCHITECT'S DRAWINGS.

PERIMETER CEILING ANGLE, WHERE OCCURS, SHALL BE INSTALLED TIGHT TO VERTICAL SURFACES, FREE FROM CURVES, BREAKS OR OTHER IRREGULARITIES AND PAINTED TO MATCH CEILING FINISH.

FURNISH AND INSTALL ALL ASSOCIATED TRIM AND SEISMIC BRACING AS REQUIRED.

LIGHT FIXTURES, NEW SPRINKLERS AND OTHER CEILING ELEMENTS SHALL BE CENTERED IN THE 2'X2' SECTION OF INDIVIDUAL CEILING TILES U.N.O. (EXIST. SPRINKLERS TO REMAIN UNLESS CONFLICT WITH NEW ELEMENTS).

PROVIDE CEILING ACCESS AS REQUIRED FOR EQUIPMENT AND SYSTEM MAINTENANCE, AND MATCH ADJACENT CEILING FINISH U.N.O.

ALL SOFFITS AND CEILING HEIGHTS ARE DIMENSIONED FROM TOP OF FINISHED FLOOR TO BOTTOM OF FINISHED GYPSUM BOARD OR CEILING TILE AND SHALL ALLOW FOR THICKNESS OF ALL FLOOR FINISHES.

- 7. THE REFLECTED CEILING PLAN INDICATES THE LOCATION OF CEILING HEIGHTS, LIGHT TYPES, LIGHT FIXTURES, AND ASSOCIATED ITEMS.
- 8. ALL SPECIFIC INFORMATION CONCERNING INSTALLATION FOR VARIOUS ABOVE-CEILING ELEMENTS ARE TO BE DESIGN BUILD, DOCUMENTATION BY OTHERS - PERMITTED SEPARATELY.
- NOTIFY ARCHITECT OF ANY CONFLICTS OF LIGHT FIXTURE LOCATIONS WITH MAIN RUNNERS, DUCTS, STRUCTURES, HVAC, AND/OR (E)CONDUIT, PRIOR TO FRAMING FOR LIGHTS. ANY DISCREPANCIES BETWEEN ARCHITECT'S CEILING GRID LOCATION & ACTUAL FIELD CONDITIONS ARE TO BE CLARIFIED WITH THE ARCHITECT PRIOR TO FRAMING.
- 10. SUBMIT GRILLE, THERMOSTAT, AND OTHER FIXTURE AND ELEMENT LAYOUTS TO THE ARCHITECT FOR REVIEW AT LEAST 2 WEEKS PRIOR TO INSTALLATION.
- 11. VERIFY FIELD CONDITIONS AND LOCATIONS OF ALL PLUMBING, MECHANICAL DUCTS, STRUCTURAL ELEMENTS AND ALL OTHER RELATED ITEMS. INSTALL NEW PLUMBING, MECHANICAL, FANS, DUCTS, CONDUITS, AND OTHER RELATED ITEMS SO AS TO NOT CONFLICT WITH ANY/ALL FIELD CONDITIONS INCLUDING LUMINAIRES.
- 12. INSTALL NEW LIGHT FIXTURES WITH PROTECTIVE FILM OR SIMILAR COVER OVER LOUVER, LENS, BAFFLE, ETC. TO AVOID FIXTURE SOILING OR DAMAGE. FIXTURES SHALL BE MAINTAINED CLEAN AND AS NEW. ALL LAMPS SHALL BE NEW AT PROJECT COMPLETION - RELAMP EXISTING FIXTURES.
- 13. CONTRACTOR TO VERIFY CODE COMPLIANCE OF EXISTING ACOUSTICAL CEILING GRID SYSTEMS AND ASSOCIATED SEISMIC BRACING RESTRAINTS. SYSTEMS FOUND NOT IN COMPLIANCE SHALL BE MODIFIED AND/OR NEW PROVIDED AS REQUIRED BY CURRENT BUILDING CODES (INCLUDING, BUT NOT LIMITED TO; CURRENT IBC WALL MOLDING (2" ANGLE) AND SEISMIC SEPARATION JOINTS).
- 14. CONTRACTOR TO VERIFY CODE COMPLIANCE OF ALL EXISTING LIGHTING FIXTURES AND ASSOCIATED SEISMIC BRACING RESTRAINTS. FIXTURES FOUND NOT IN COMPLIANCE SHALL BE MODIFIED AND/OR NEW PROVIDED AS REQUIRED BY CURRENT BUILDING AND/OR ENERGY COMPLIANCE CODES.
- 15. ALL EXITING LIGHTS AND EGRESS LIGHTING LOCATIONS SHALL BE DETERMINED BY BUILDING AND FIRE INSPECTOR'S FIELD PLACEMENT DETERMINATION.

16. ALL SMOKE DAMPERS SHALL BE INSTALLED IN ACCORDANCE WITH IMC/IBC OR SUPERCEDING CODE. ALL FIRE DAMPERS SHALL BE INSTALLED IN ACCORDANCE WITH IMC/IBC OR SUPERCEDING CODE.

17. EGRESS LIGHTING SHALL BE DESIGNED BY A LICENSED ELECTRICAL ENGINEER BASED ON FINAL FLOOR PLAN(S) AND THE MOST CURRENT (IN FORCE) ISSUE OF THE IBC, IEC AND LOCAL CODES/ORDINANCES. THE ENGINEER MAY USE THE ARCHITECTS EGRESS MAPS (COMMON PATH OF TRAVEL/EXIT TRAVEL DISTANCE) AS STARTING POINT FOR A BASIS OF DESIGN. HOWEVER, IT SHALL REMAIN THE SOLE RESPONSIBILITY OF THE LIGHTING I.E.; ROOMS, SPECIALIZED SPACES, PATHWAYS, ETC. PER THE AFOREMENTIONED CODES. FINAL EGRESS LIGHTING QUANTITIES AND LOCATIONS SHALL BE DETERMINED BY BUILDING AND FIRE INSPECTOR'S

ENGINEER TO COMPLETE A SCOPE OF WORK THAT ADDRESSES ALL EGRESS

FIELD PLACEMENT DETERMINATION.

NO DESIGNATION = EXISTING

<u> 3</u> (

F-7

N = NEW &/OR RELOCATED (COORDINATE RELOCATED ITEMS W/ARCHITECT)

MFG.

FOCAL POINT

NULITE

ECOSENSE

GEORGE

KOVACS

LIGHTING

SWITCH

3WAY SWITCH

LIGHT FIXTURE

2-T8 WW LAMPS

QUAD LAMPS

#NU-24-120.

ECOSPEC LINEAR INT

ÖR APPROVED EQUAL

BLDG STD EXIT LIGHT

EXTG BLDG STD 2x4 SUSP. CEILING GRID & TILE

EXTG BLDG STD FLU. STRIP

BLDG STD 2x4 FLU. LIGHT

FIXTURE: LUNA #FLU24B

BLDG STD RECESSED, FLU.

DOWNLIGHT FIXTURE, 2-13W

FLU. UNDER—CABINET LIGHTING.

PROVIDE SWITCH AT COUNTER. 6"D FLUOR. DOWNLIGHT FOR WET APPLICATION— LIGHTOLIER CALCULITE CFL LENSED DOWNLIGHT #8091FCLW, OR APPROVED EQUAL

#04LC-XX-3500K-120-120.

CEILING-MOUNTED PROJECTOR

VERIFY EXACT LOCATION WITH

TENANT'S A/V VENDOR

WALL SCONCE #P5040-37B.

DIMS: 4.75"Wx13.25"Hx4"PROJ.

-LAMPS: 2-40W XENON

#PKL3240PAL WITH MONO-POINT

GLASS SHADE: OPAL CYLINDER

CANOPY. FINISH: SATIN NICKEL.

MTG HT: BOTTOM OF SHADE TO

LAMP: 5W LED-2700K

FINISH: DARK RESTORATION

GLASS: ETCHED OPAL.

LED PENDANT KIT

MATCH EXISTING

BRONZE.


DESCRIPTION

4100 Carillon Pt.

Kirkland, WA 98033


Finish Plan and Finish Schedule - 3rd Floor


1-6.3

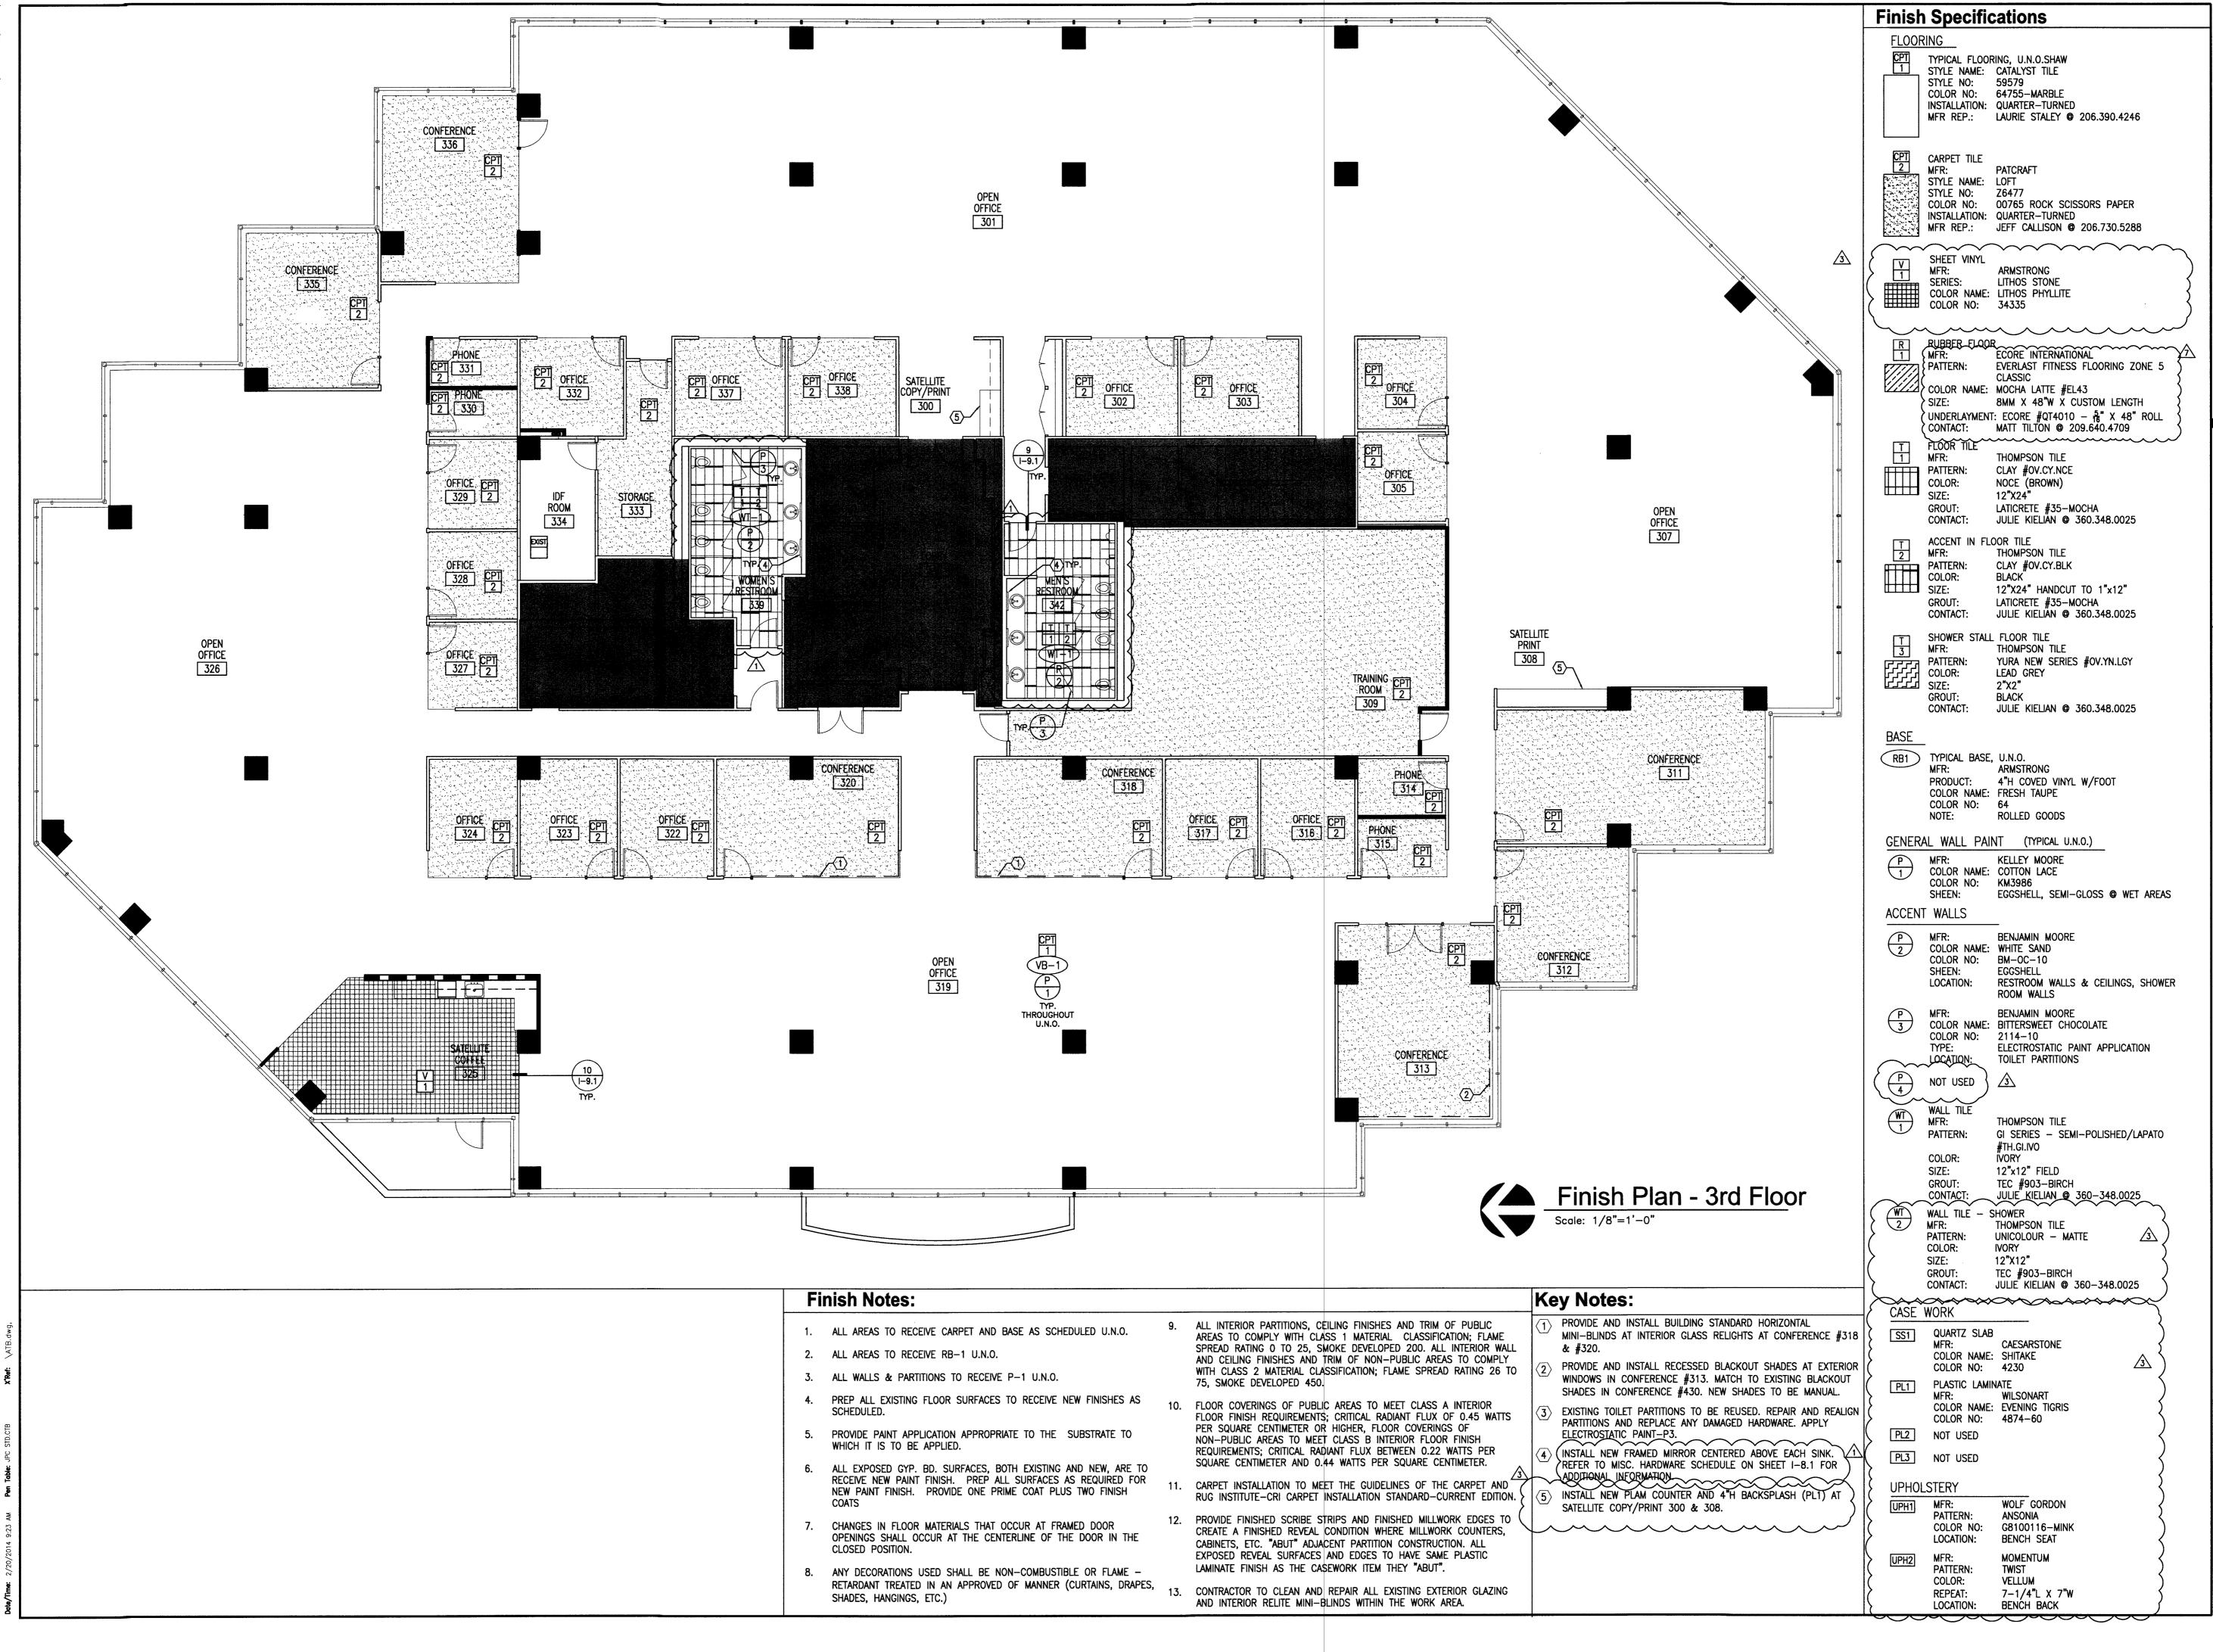


Finish Plan and Finish Schedule - 4th Floor

I-6.4

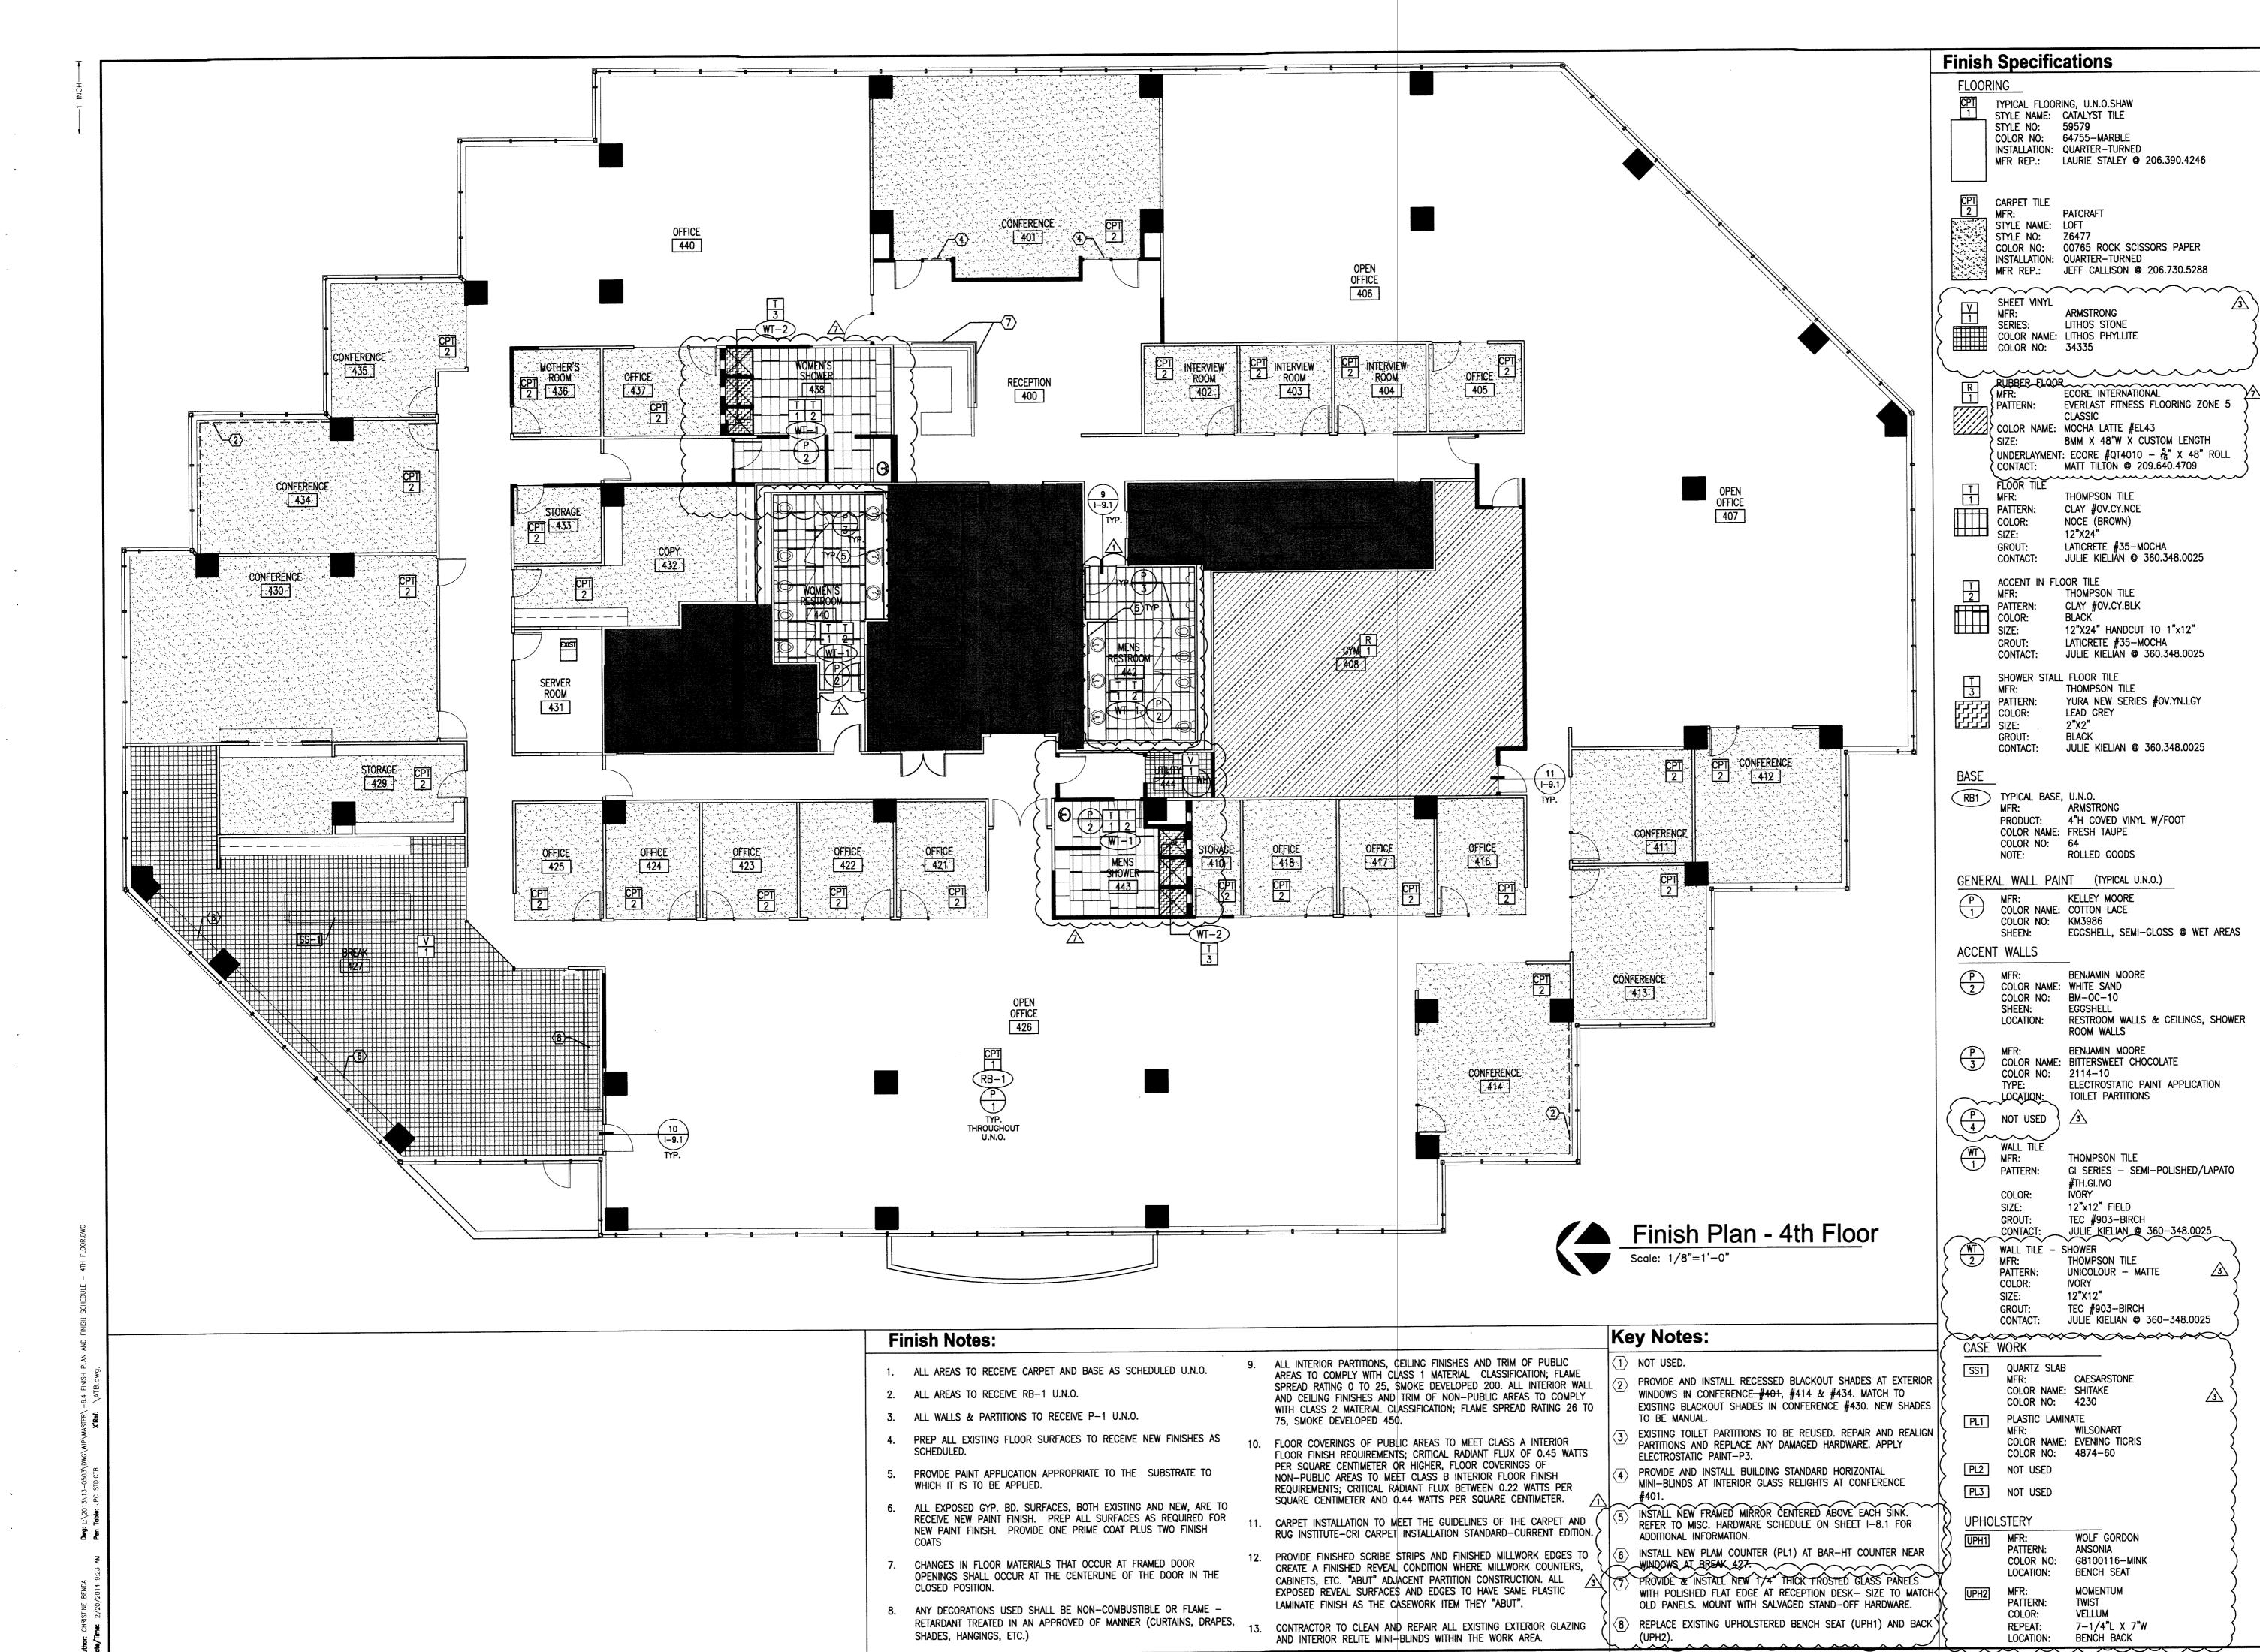

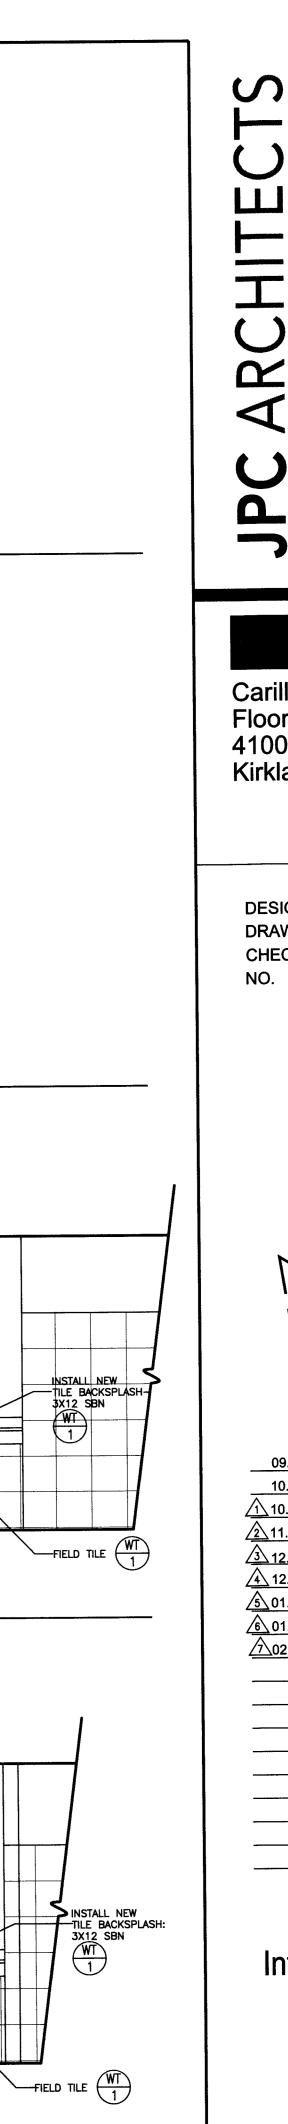

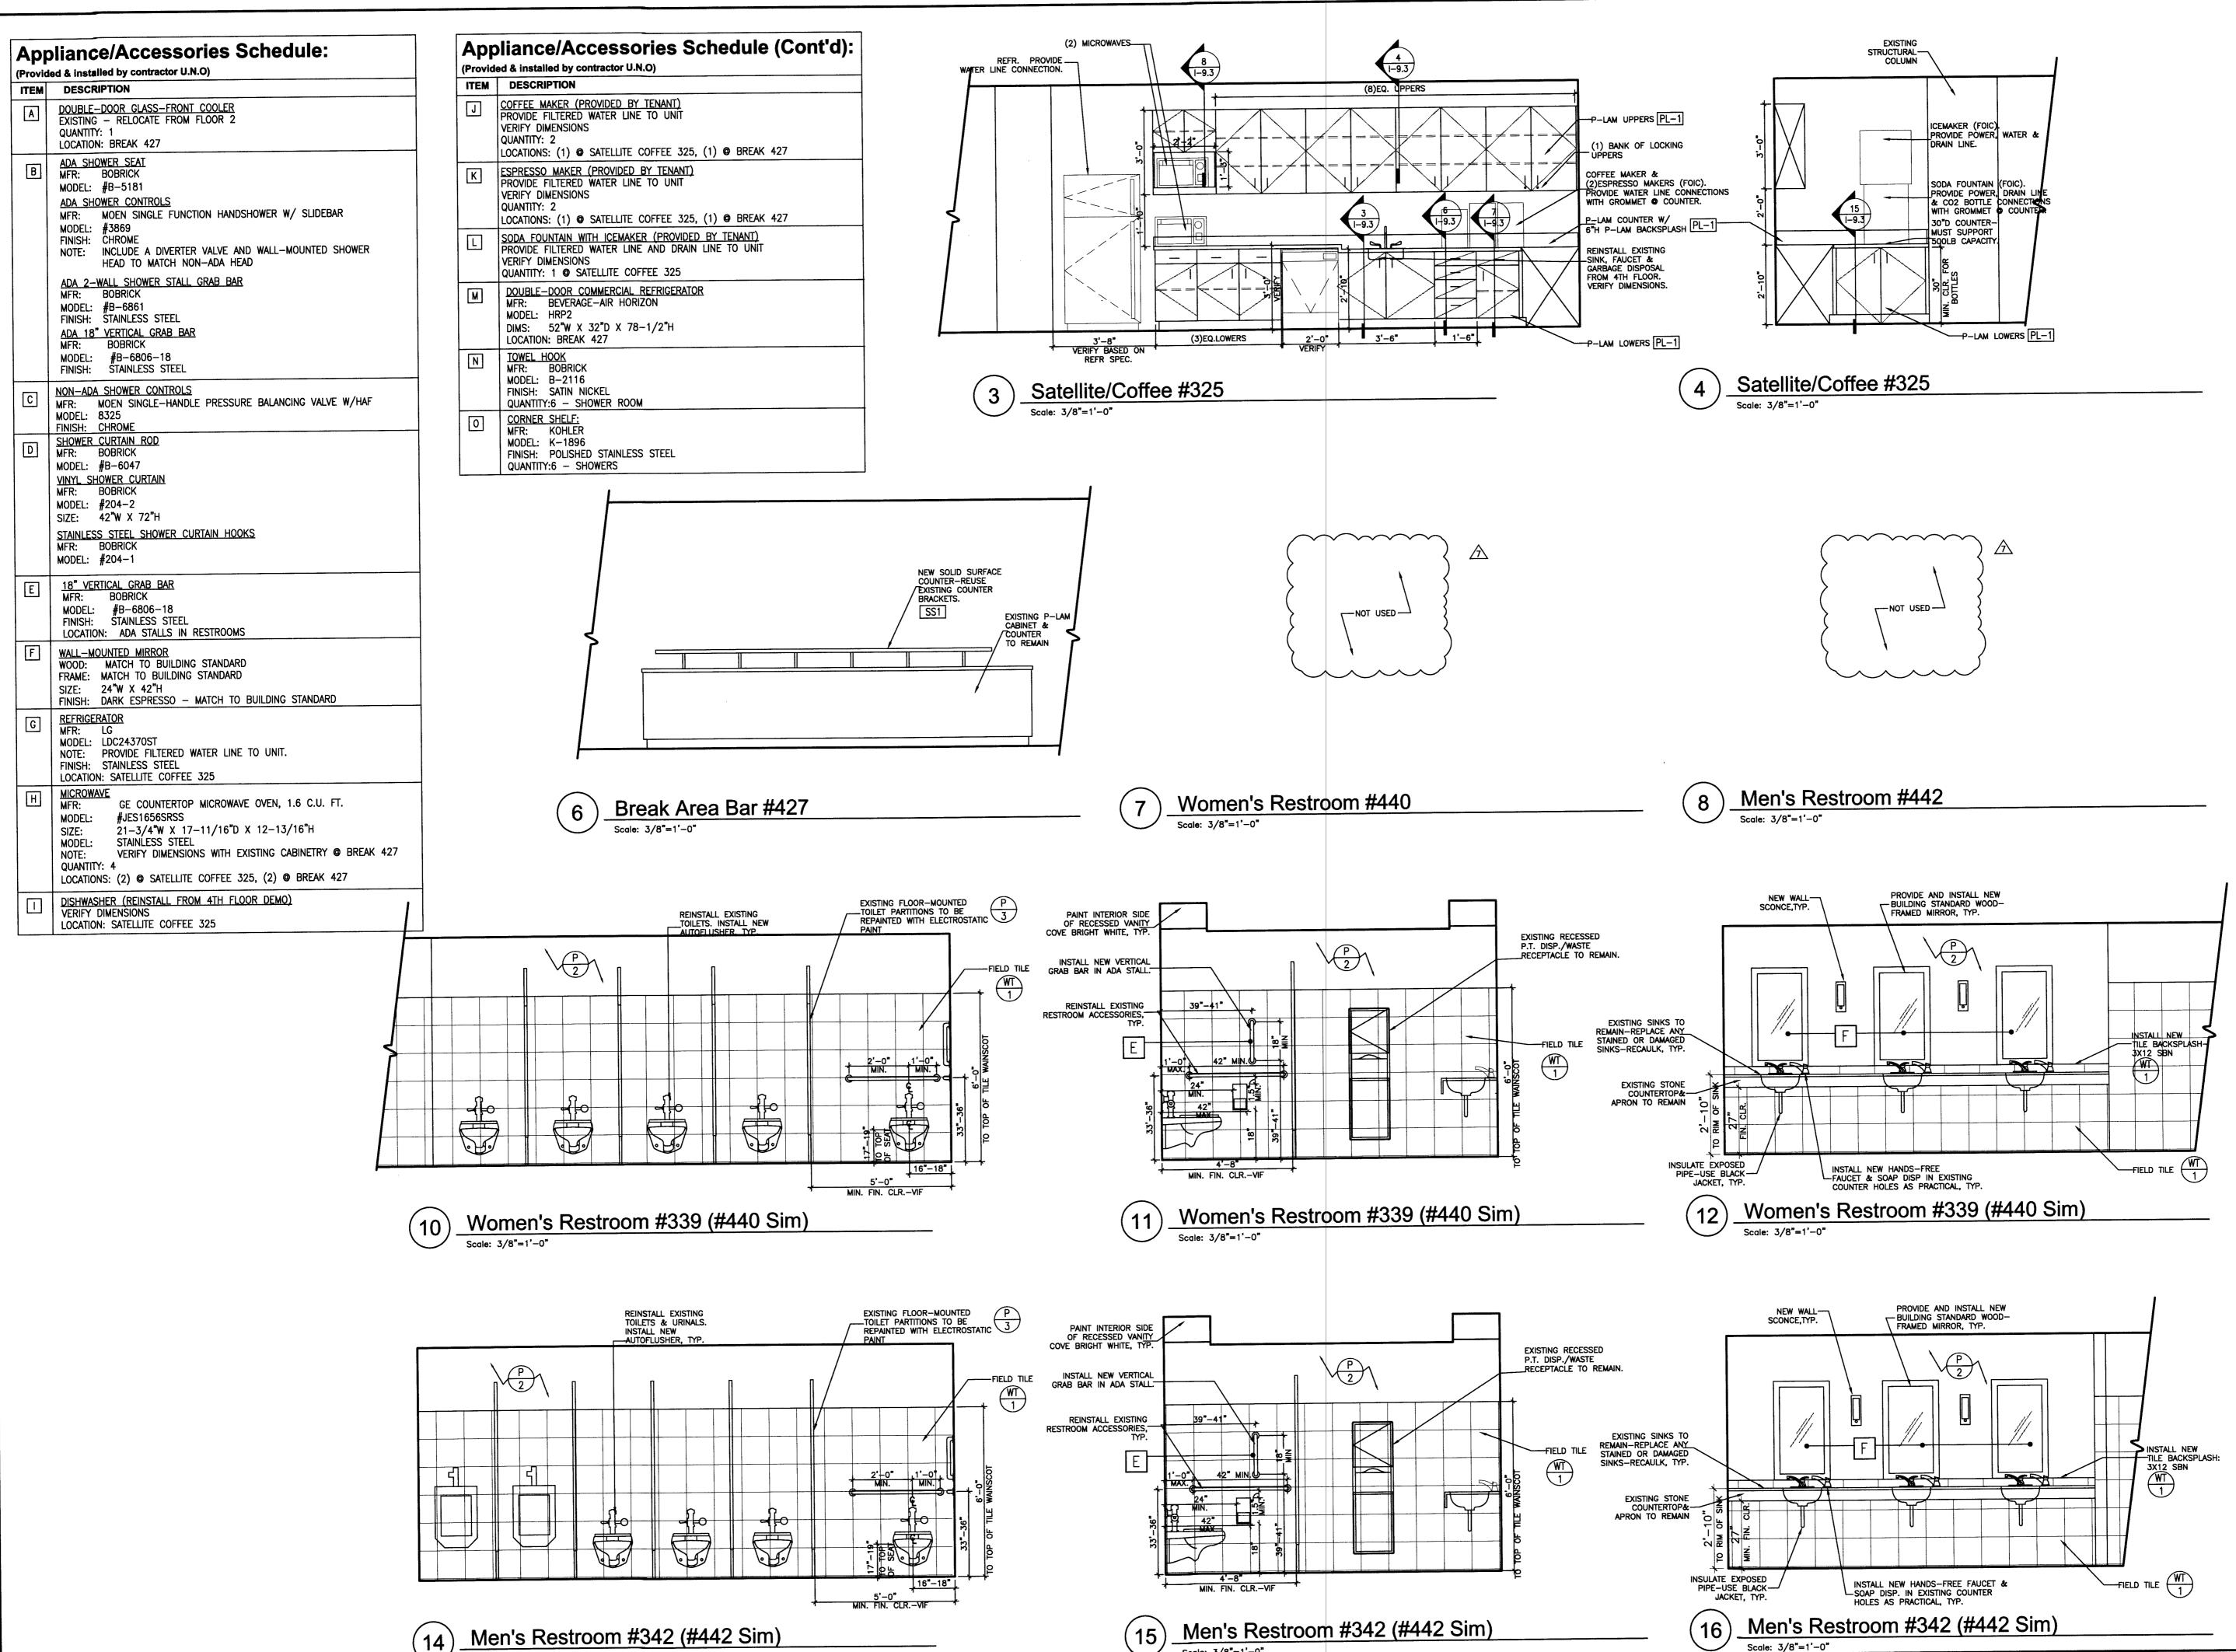

Carillon Point B4000 Floors 3 & 4 4100 Carillon Pt. Kirkland, WA 98033

DESIGN DRAWN AN/CB **CHECKED** 13-0503

09.30.13 Progress Set 10.09.13 Permit / Bid Issue /1\10.22.13 ASI #1 2 11.25.13 ASI #2 /3\12.17.13 CD Issue 4 12.20.13 ASI #3 <u>∕</u>5 01.09.14 ASI #4 6 01.29.14 ASI #5 <u>√7</u>02.20.14 Permit Revision

Interior Elevations

I-8.1

Floors 3 & 4 4100 Carillon Pt. Kirkland, WA 98033

DESIGN DRAWN CHECKED NO. 13-0503

09.30.13 Progress Set 10.09.13 Permit / Bid Issue 10.22.13 ASI #1 <u>2</u>11.25.13 ASI #2 3 12.17.13 CD Issue 12.20.13 ASI #3 <u>√</u>5 01.09.14 ASI #4 <u>6</u>01.29.14 ASI #5 202.20.14 Permit Revision

> Enlarged Plans & **Interior Elevations**

> > 1-8.2


© 2013, JPC Architects, PLLC

Women's Shower #438 - Enlarged Plan


Scale: 1/4"=1'-0"

PROVIDE NEW STAINLESS
STEEL SEMI-RECESSED
P.T. & WASTEDISPENSER TO MATCH
BUILDING STANDARDPROVIDE SUBMITTAL.

Men's Shower #443 (Women's Shower #438 SIM)

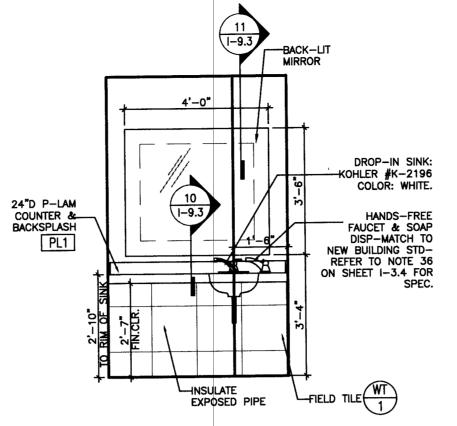


Men's Shower #443 (Women's Shower #438 SIM)

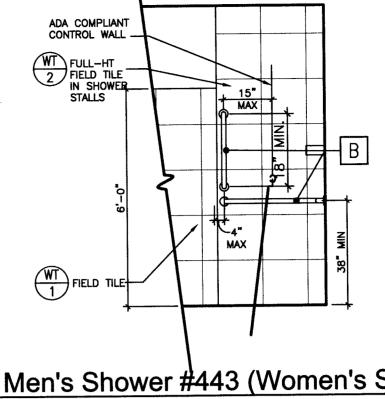


Men's Shower #443 (Women's Shower #418 SIM)

Scale: 3/8"=1'-0"

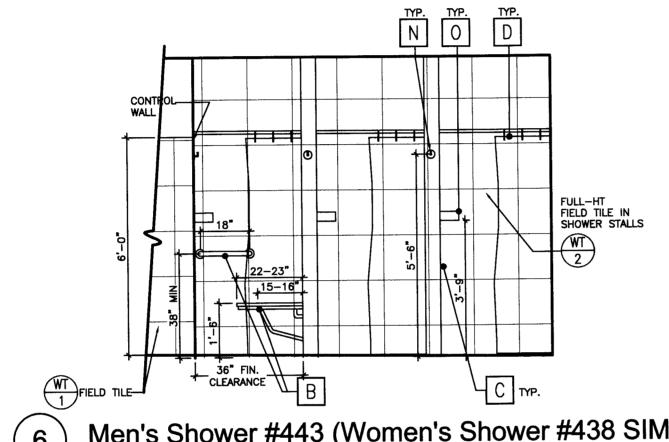


Men's Shower #443 (Women's Shower #438 SIM)

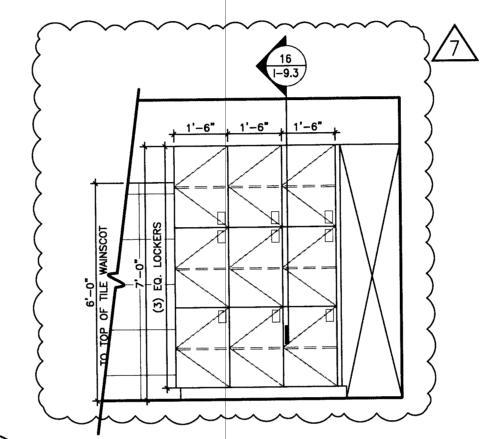


Men's Shower #443

3'-0" † FIN.CLR. †

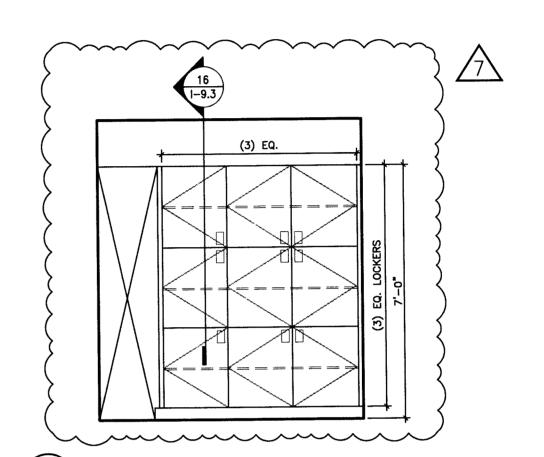


Men's Shower #443

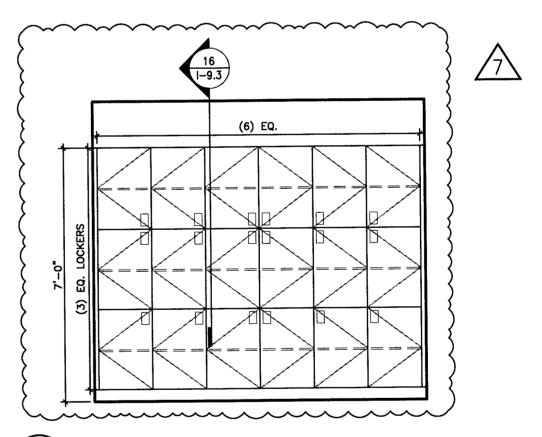


Women's Shower #438

Scale: 3/8"=1'-0"

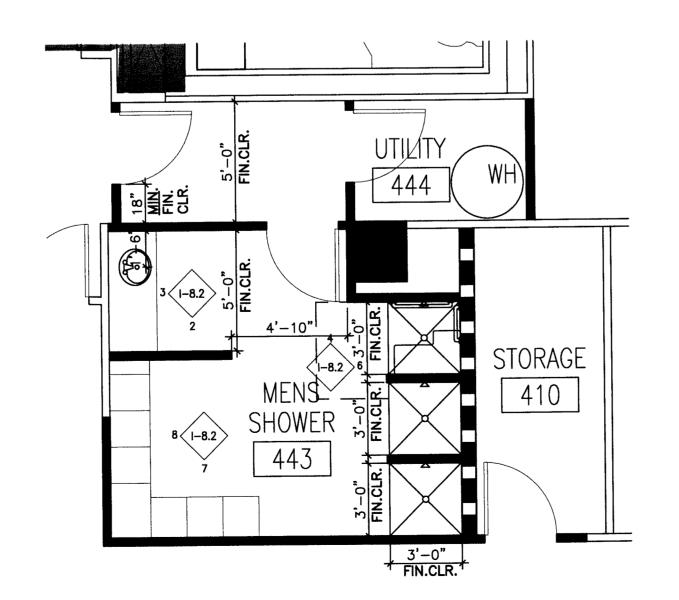

Men's Shower #443 - Enlarged Plan

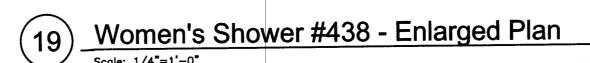

WOMEN'S SHOWER 438

4'-0" 3'-0" 1 FIN.CLR. 1 FIN.CLR.

l (1-8.2) 12

MTL STUD (GA. TO MATCH

8'-0" O.C. AT ALTERNATE

WALL STUDS) AT MAX.

SIDES

-SUSPENDED

CEILING

13-0503

4100 Carillon Pt.

Kirkland, WA 98033

09.30.13	Progress Set
10.09.13	Permit / Bid Issue
∆10.22.13	ASI #1
∆11.25.13	ASI #2
12.17.13	CD Issue
∆ 12.20.13	ASI #3
∑ 01.09.14	ASI #4
∆ 01.29.14	ASI #5
02.20.14	Permit Revision

Construction & Ceiling **Details**

I-9.1

NON-BEARING WALL HEIGHT TABLE NOTES

1. WALL HEIGHTS ARE BASED ON ALLOWABLE DEFLECTION OF L/240. WALLS ARE TO RECEIVE MINIMUM 1/2" GWB BOTH SIDES. 3. IF WALL HEIGHT FOR COMPOSITE ACTION

IS USED, GWB IS TO BE FASTENED WITH MINIMUM #6 SCREW AT 12" O.C. HEIGHTS ARE BASED ON THE SSMA

CATALOG. TABLES ARE BASED ON 5 PSF LATERAL

TABLES TO BE USED FOR NON-BEARING NON-STRUCTURAL STUD WALLS ONLY.

MATERIAL GAUGES ARE FOR REFERENCE

WHERE GWB DOES NOT EXTEND TO TOP OF STUDS USE LIMITING WALL HEIGHTS FOR NON COMPOSITE WALLS AND PROVIDE MECHANICAL BRACING OF STUD FLANGES PER SSMA STANDARDS.

-FILL VOID WITH ACOUSTICAL SEALANT BOTH SIDES

- SECURE STUDS TO LEG OF HEAD TRACK

- ONE LAYER 5/8" GWB EACH SIDE OF WALL

-INSULATION TO EXTEND 2'-0" BEYOND EACH

COMMENTS

- EXISTING STRUCTURE

(INNER) HEAD TRACK

- CEILING AS SPECIFIED

- SPECIFIED BASE

FINISHED FLOOR

- (OUTER) DEFLECTION TRACK

- INSULATION AS NOTED BELOW

SIDE OF WALL AS NOTED BELOW

- EXISTING PARTITION TO REMAIN

SB SB

*SB=SOUND ATTENUATION BATTS FR=FIRE RESISTIVE

VINYL/ VINYL TILE

SCHLUTER: RENO-U TRANSITION PROFILE

- STAINLESS STEEL

FINISH

- CARPET

FEATHERING

COMPOUND TO 12"

-ONE LAYER 5/8" GWB EACH SIDE OF WALL -MTL. STUDS - WIDTH, GA. & SPACING AS NOTED BELOW CONT. MTL. RUNNER MECHANICALLY FASTENED TO SUB-FLOOR WITH STEEL NAILS EVERY 24" O.C. WITH AN EMBED. DEPTH OF 1/2", 3/4" AT PT SLAB - SPECIFIED BASE FINISHED FLOOR

SHIM AS REQ'D, SECURE TO GRID

OF WALL AS NOTED BELOW

(MATCH EXISTING CONDITION)

INSULATION AS NOTED BELOW


CEILING AS SPECIFIED

INSULATION TO EXTEND 2'-0" BEYOND EACH SIDE

PAINT REVEAL FLAT BLACK OR TAPED BLACK

WALL TYPE WALL HT.	STUD SIZE	STUD THICKNESS	STUD SPACING	WALL THICKNESS	INSUL WALL		FIRE RATING/ UL DESIGN NO.	COMMENTS
TIPE 3	2 1/2"	25 GAUGE	24" 0 0	3 3/4"	SB	SB	UL DESIGN NO.	REF. 4/I-9.1
A (VERIFY)	2 1/2	25 GAUGE	24 0.6.	3 3/4	1		UATION BATTS	FR=FIRE RESISTIV

Grid Ht. Partition Scale: 3"=1'-0"

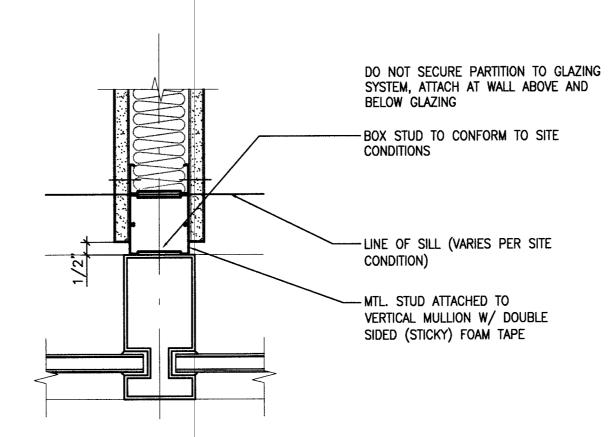

SCHEDULED DOOR -(OPEN OR CLOSED) --- WALL-MOUNTED TEL. OUTLET ⊢LIGHT SWITCH THERMOSTAT DOTTED LINE INDICATES LOCATION ' — Ļ Ç @ HANDLE OF LARGER PLATE FOR GANGED HARDWARE SET-SWITCHES AS SCHEDULED 2-3/4" BUILDING STANDARD ---VERIFY W/ ELEC. OUTLET -FIRE EXTINGUISHER HARDWARE CABINET TEL. OUTLET -**SCHEDULE** WHEN LOCATED AT COLUMNS, CABINET AND SIGNAGE TO BE CENTERED ON COLUMN ENCLOSURE. TYPICAL, U.N.O. NOTE: HEIGHTS ARE AS NOTE UNLESS DIRECTED BY B/S TO BE DIFFERENT

STRUCTURE -


SPECIFIED -


PARTITION

Partition Bracing Detail


APPROX. 45

Typical Mullion/Partition Intersection

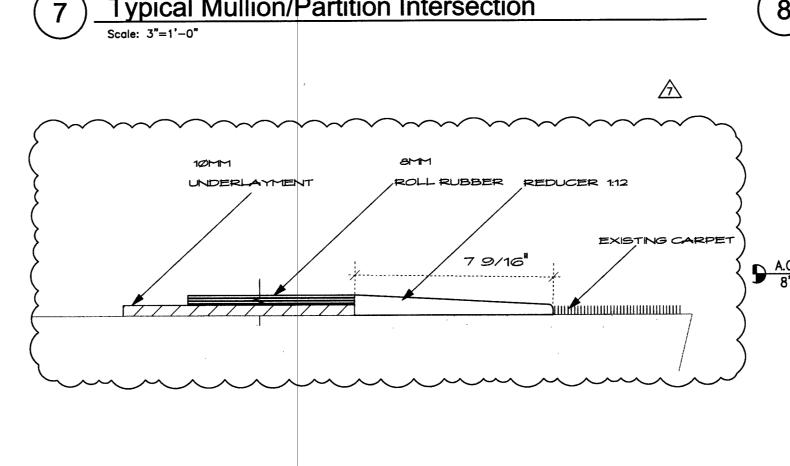

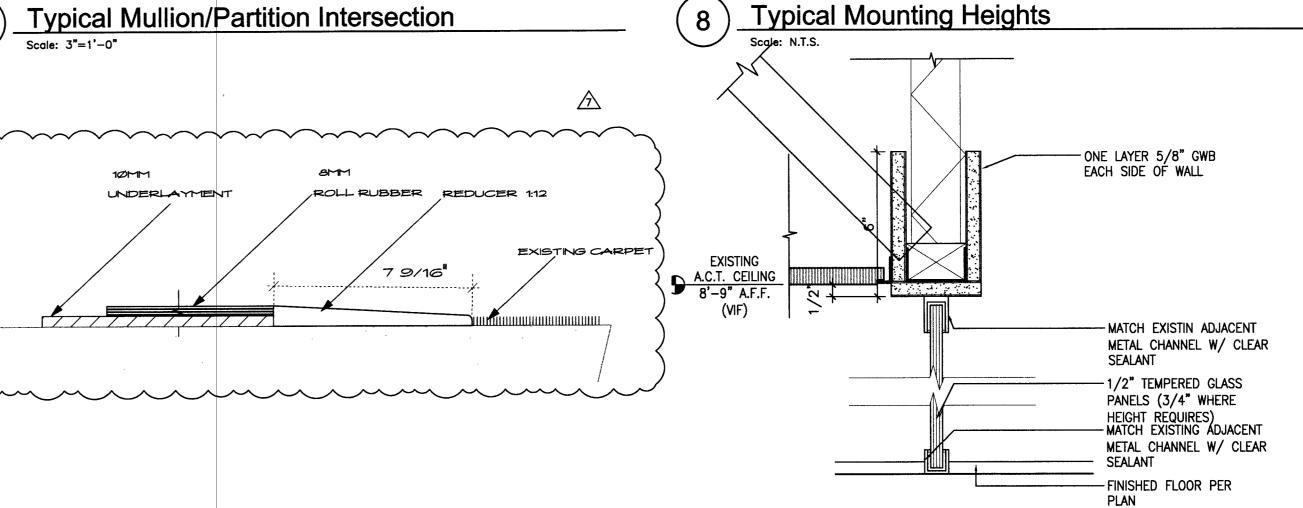




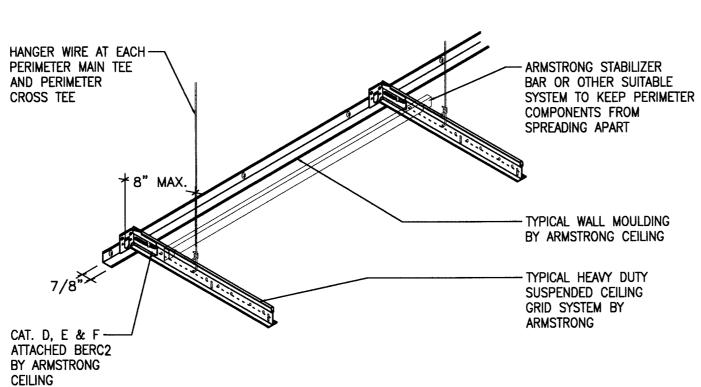

Lighting Fixture Bracing Diagram

NO. 9 GA. LATERAL SUPPORT WIRE WITHIN 3' OF EACH CORNER OF LIGHT FIXTURE. SPLAY WIRES AS SHOWN AND FASTEN TO BEAM OR PURLIN. MIN. OF 3 WIRE TURNS EACH. CONNECTION POINT NO. 9 GA. LATERAL SUPPORT WIRE AT-CENTER ENDS OF EA. FIXTURE. FIXTURE SUPPORT WIRE SUPPLIED BY CEILING CONTRACTOR RECESSED FLUORESCENT CROSS TIE

Rubber Tile to Carpet Tile Transition Detail

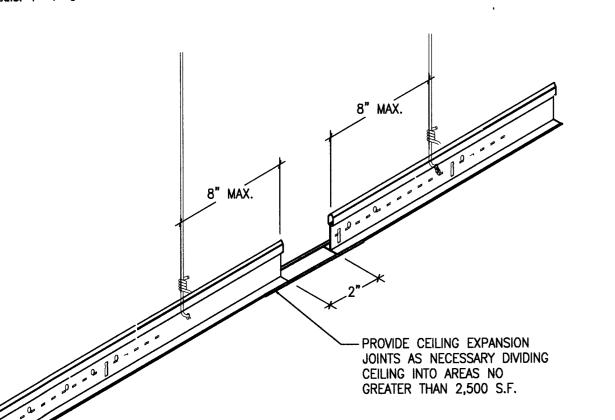

Expansion Joint for Ceiling Exceeding 2500 SF

18 mils STUDS (25 GA)

SIZE | SPACING NON-COMPOSITE

STUD

162S125 12"

(1-5/8") 16"

250S125 12"

362S125 12"

400S125 12"

600S125 12"

I-9.1

3-5/8"

24"

16"

24"

16"

24"

16"

24"

LIMITING WALL HEIGHT

6'-11"

6'-0**"**

10'-6""

9'-6"

7'-7"

12'-9"

12'-7"

COMPOSITE

8'-10"

8'-4"

7'-11"

11'-11"

11'-3"

10'-7"

15'-4"

14'-4"

13'-5"

16'-5"

15'-4"

14'-2"

22'-1"

19'-9"

16'-9"

30 mils STUDS (20 GA - DRYWALL)

SIZE | SPACING NON-COMPOSITE |

STUD

24"

24"

24"

16"

24"

16"

24"

INSULATION TO EXTEND 2'-0" BEYOND EACH SIDE

-PAINT REVEAL FLAT BLACK OR TAPED BLACK

-ONE LAYER 5/8" GWB EACH SIDE OF WALL

- CONT. MTL. RUNNER MECHANICALLY FASTENED

TO SUB-FLOOR WITH STEEL NAILS EVERY 24" O.C.

WITH AN EMBED. DEPTH OF 1/2", 3/4" @ PT SLAB

- MTL. STUDS - WIDTH, GA. & SPACING

162S125 12"

1(1-5/8") 16"

250S125 12"

1(2-1/2") 16"

362S125 | 12"

13-5/8" 16"

400S125 12"

600S125 | 12"

-SHIM AS REQ'D, SECURE TO GRID

OF WALL AS NOTED BELOW

-INSULATION AS NOTED BELOW

- CEILING AS SPECIFIED

AS NOTED BELOW

- SPECIFIED BASE

-FINISHED FLOOR

-1/8" FOAM TAPE

- TILE

ALUM. TILE SCREED

BUTT CARPET TIGHT

TO METAL EDGE

CARPET TILE

BY SCHLUTER SYSTEMS OR APPROVED EQUAL.

APPLY EXTRA SEAM SEALER

FEATHERING COMPOUND TO 12"

CONC. FLOOR LEVELED

1/8" THINSET

WALL TYPE WALL HT. STUD SIZE STUD THICKNESS STUD SPACING WALL INSULATION FIRE RATING/THICKNESS WALL CEILING UL DESIGN NO.

Tile to Carpet Tile Transition Detail

C 8'-9" 3 5/8" 30 Mils 24" O.C. 4 7/8" SB SB

Grid-Height Plumbing Partition

Scale: 3"=1'-0"

(4")

(6")

LIMITING WALL HEIGHT

9'-2"

8'-4"

7'-3"

12'-9"

11'-7"

10'-1"

16'-6**"**

15'-0**"**

13'-1"

18'-4"

16'-8"

14'-7"

25'-5"

23'-1"

20'-2"

NON-BEARING NON-STRUCTURAL LIMITING WALL HEIGHT TABLES

COMPOSITE

9'-11"

9'-2"

8'-3"

13'-2"

12'-1"

10'-9"

17'-1"

15'-8"

14'-0"

19'-0**"**

17'-6"

15'-7**"**

25'-6"

23'-2"

20'-3"

COMMENTS

*SB=SOUND ATTENUATION BATTS FR=FIRE RESISTIVE

33 mils STUDS (20 GA)

STUD STUD

162S125 12"

(1-5/8") 16"

250S125 12"

(2-1/2") 16"

362S125 12"

400S125 12"

600S125 12"

DESIGNED

DEFLECTION

3-5/8"

(4")

(6")

24"

24"

16"

24"

16"

16"

24"

LIMITING WALL HEIGHT

10'-4"

9'-8"

8'-9"

13'-11"

12'-10"

11'-7"

17'-10"

16'-5**"**

14'-9"

19'-11"

18'-4"

16'-5**"**

26'-9"

24'-6"

21'-7"

WALL TYPE WALL HT. STUD SIZE STUD SPACING WALL INSULATION THICKNESS WALL CEILING

Extended Partition to Full-Height

B (12'-0" 2 1/2" 18 Mils 24" O.C. 3 3/4"

SIZE SPACING NON-COMPOSITE COMPOSITE-note 3

9'-6"

8'-7"

7'-6"

13'-2"

11'-11"

10'-5"

17'-1"

15**'**–6"

13'-6"

18'-11"

17'-3"

15'-0"

26'-3"

23'-11"

20'-10"

Suspended Ceiling @ Perimeter Support

Typical Header @ Private Office & Conference

NOTES:

1. LATERAL BRACING CLUSTER: (4) 12 GA. GALV. SOFT—ANNEALED MILD STEEL WIRES SECURED TO MAIN RUNNER

1. LATERAL BRACING CLUSTER: (4) 12 GA. GALV. SOFT—ANNEALED MILD STEEL WIRES SECURED TO MAIN RUNNER

1. LATERAL BRACING CLUSTER: (4) 12 GA. GALV. SOFT—ANNEALED MILD STEEL WIRES SECURED TO MAIN RUNNER MILD STEEL WIRES SECURED TO WITHIN 2" OF CROSS 'T' AND SPLAYED 90 DEGREES FROM EACH OTHER AT 45 DEGREES MAX. ABOVE HORIZONTAL. CLUSTERS PLACED 12'-0" O.C. MAX. AND 6'-0" MAX. FROM EACH WALL. WIRES SHOULD BE TAUT WITHOUT CAUSING CEILING TO LIFT.

2. SUSPENSION WIRE: 12 GA. GALV. SOFT-ANNEALED MILD STEEL WIRE ENCASED IN 2" DIAM. CONDUIT (FOR UPLIFT RESTRAINT); SECURE WIRE TO MAIN RUNNER WITHIN 2" OF CROSS 'T'. CONDUIT TO OCCUR AT EVERY LATERAL BRACING CLUSTER AND SUSPENSION WIRES TO OCCUR AT 4'-0" O.C. MAX. EACH WAY.

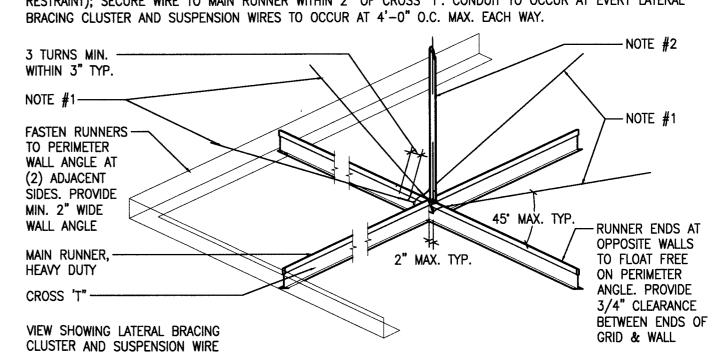

Ceiling Bracing Diagram

MAIN STRUCTURAL

RUNNER 4'-0" O.C.



10.09.13	Permit / Bid Issue ASI #1
<u> </u>	ASI #2
12.17.13	CD Issue
12.20.13	ASI #3
<u></u> 01.09.14	ASI #4
<u></u> 01.29.14	ASI #5
02.20.14	Permit Revision

Casework Details

I-9.3

© 2013, JPC Architects, PLLC

PLAM AT ALL EXPOSED — EXTERIOR SURFACES TYPICAL 3/4" ADJUSTABLE — SHELF ON 2" O.C. SHELF CLIPS WIRE PULLS--MATCH TO EXISTING PROVIDE BLOCKING —— BEHIND CABINET AND IN WALL AS REQUIRED m m Under Cabinet Light — Fixture—see reflected Ceiling Plan For Locations

Upper Cabinet with U.C. Lighting

Base Cabinet with Sink - ADA Side Approach

2'-0" U.N.O.

WIRE PULLS———— MATCH TO EXISTING

PLAM AT ALL -EXTERIOR SURFACES TYPICAL

4" RUBBER BASE AT TOE KICK

2'-0" U.N.O.

2'-0" U.N.O.

WIRE PULLS— MATCH TO EXISTING

REFER TO ELEVATION – FOR DRAWER AND BOX CONFIGURATION

4" RUBBER BASE — AT TOE KICK

Base Cabinet

PLAM COUNTER TOP —— AND EDGE

4"H PLAM BACKSPLASH —

CONCEALED TUBE STEEL-

ADA Sink Counter

CONTINUOUS LEDGER TO MATCH WALL

INSULATE EXPOSED — PIPE

-PLAM COUNTER TOP

- PROVIDE BLOCKING BEHIND CABINET AND

IN WALL AS REQUIRED

— MELAMINE AT ALL CABINET INTERIORS TYPICAL

AND BACKSPLASH

-PLAM COUNTER TOP

AND BACKSPLASH

- PROVIDE BLOCKING


BEHIND CABINET AND IN WALL AS REQUIRED

-- REINSTALL SALVAGED SINK & FAUCET

-INSULATED EXPOSED


- MELAMINE AT ALL INTERIOR SURFACES TYPICAL


DRAIN PIPING

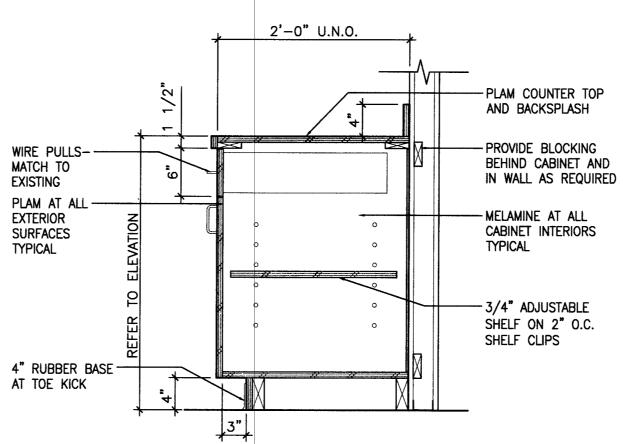


PLAM AT ALL EXPOSED -EXTERIOR SURFACES TYPICAL WIRE PULLS-MATCH TO EXISTING PLAM AT ALL EXPOSED — EXTERIOR SURFACES TYPICAL PROVIDE BLOCKING —— BEHIND CABINET AND IN WALL AS REQUIRED EXTENDED PLAM SHELF W/RADIUSED CORNER NO UNDERCABINET LIGHT -MICROWAVE CABINET

Upper Cabinet W/Microwave Shelf & U.C. Lighting

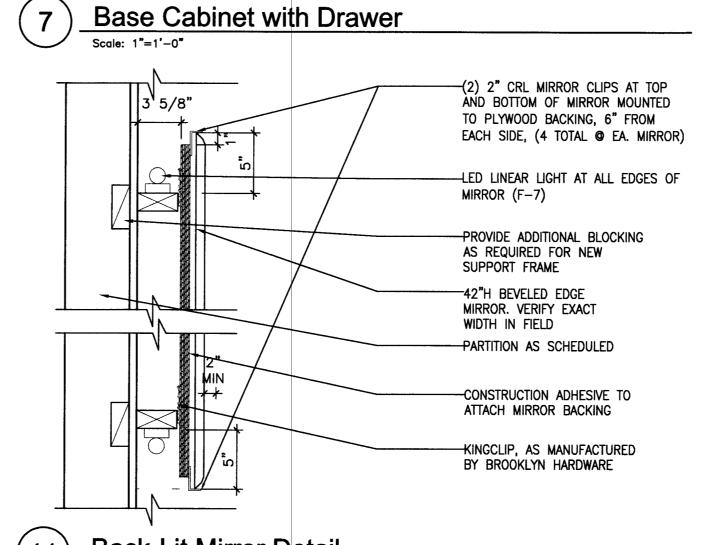

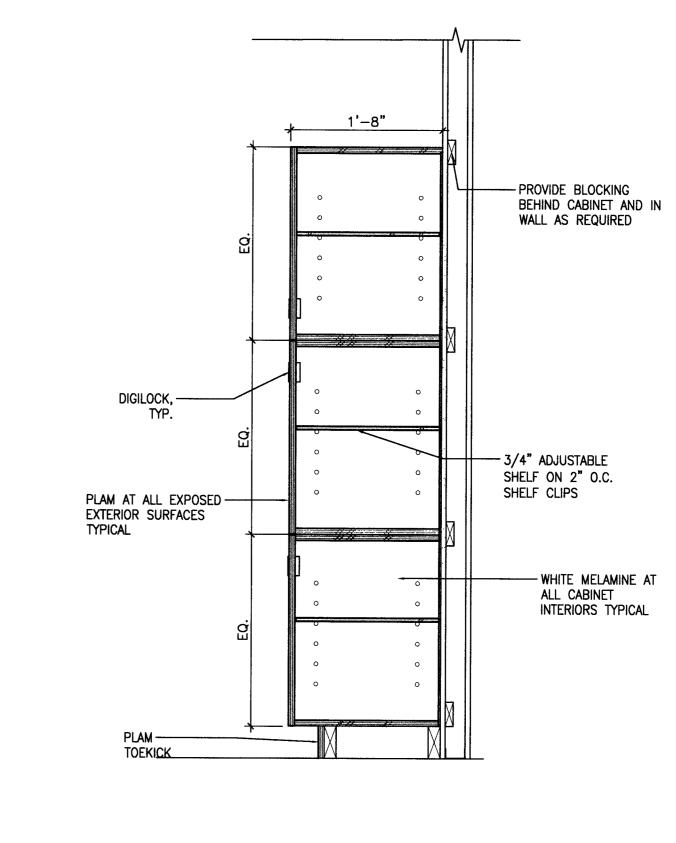

Lockers at Shower Rooms

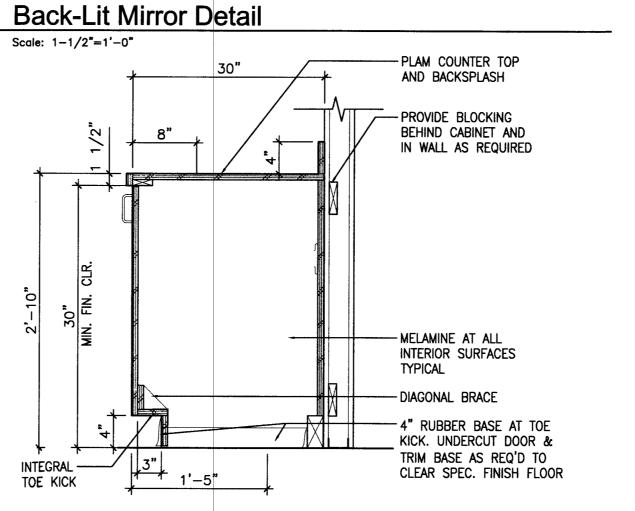

Base Cabinet w/Integral Toekick


DESIGN DRAWN AN/CB CHECKED AN 13-0503 NO.

09.30.13	Progress Set
10.09.13	Permit / Bid Issue
10.22.13	ASI #1
<u>2</u> 11.25.13	ASI #2
<u> </u>	CD Issue
12.20.13	ASI#3
<u>\$\sqrt{5}\\ 01.09.14</u>	ASI #4
<u>6</u> 01.29.14	ASI #5
<u> 7</u> 02.20.14	Permit Revision

Door Elevations & Details


I-10.1

© 2013, JPC Architects, PLLC

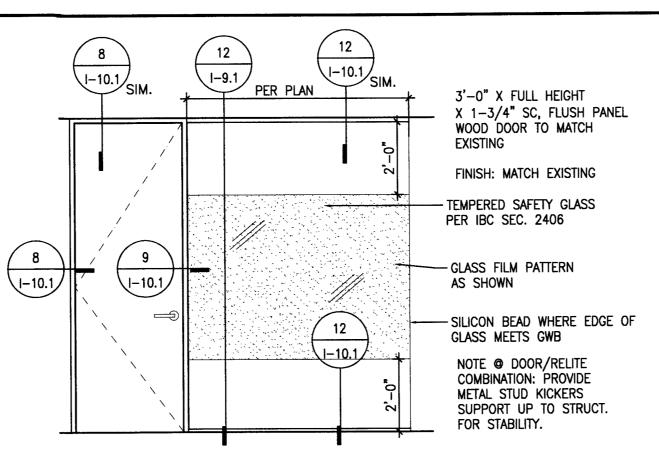

Door Type A

Scale: 3/8"=1'-0"

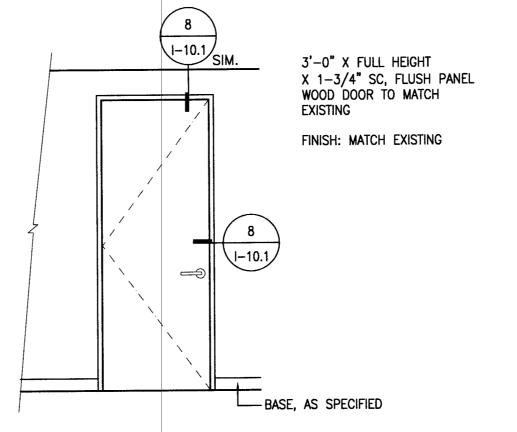


12 I-10.1 SIM. I-10.1 SIM. 3'-0" X FULL HEIGHT X 1-3/4" SC, FLUSH PANEL WOOD DOOR TO MATCH **EXISTING** FINISH: MATCH EXISTING -1/4" TEMPERED SAFETY GLASS PER IBC SEC. 2406 1-10.1 1-10.1 1-10.1 ---- GLASS FILM PATTERN AS SHOWN NOTE @ DOOR/RELITE COMBINATION: PROVIDE METAL STUD KICKERS SUPPORT UP TO STRUCT. FOR STABILITY. BASE, AS SPECIFIED

Door Type C

Scale: 3/8"=1'-0"

Door Type B Scale: 3/8"=1'-0"

WOOD VENEER FRAME,
MATCH TO EXISTING DOOR PER -SCHEDULE DOUBLE STUDS AT EACH
SIDE OF JAMBS SHIM AS REQUIRED -

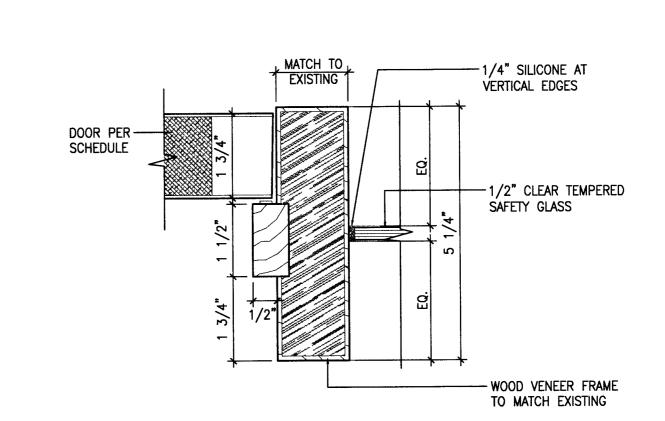

Door/Relite Jamb

Door Jamb (Head Similar)

Scale: 6"=1'-0"

1/4" SILICONE @ — VERTICAL EDGES 1/2" TEMPERED CLEAR SAFETY GLASS DOUBLE STUDS AT EACH
SIDE OF JAMBS FINISHED GWB END-- SPECIFIED PARTITION

-1/2" TEMPERED GLASS
PANELS (3/4" WHERE
HEIGHT REQUIRES) - MATCH TO EXISTING
ADJACENT METAL CHANNEL
W/ CLEAR SEALANT

Relite Jamb

Glazing Sill (Head Similar)

Scale: 3*=1'-0*

 	<u>-</u>
L	
	_
	ノヒ
< (Į)

Carillon Point B4000 Floors 3 & 4 4100 Carillon Pt. Kirkland, WA 98033

DESIGN DRAWN CHECKED NO.



09.30.13	Progress Set
10.09.13	Permit / Bid Issue
10.22.13	ASI #1
11.25.13	ASI #2
3 12.17.13	CD Issue
12.20.13	ASI #3
5 01.09.14	ASI #4
6 01.29.14	ASI #5
702.20.14	Permit Revision
	4
7	

Door Schedule and Hardware

I-10.2

© 2013, JPC Architects, PLLC

Doo	r Schedule:					
NO.	TYPE	FRAME	HDWE	RATING	REMARKS	REVISION
300A	EXISTING	EXISTING	EXISTING			
300B	EXISTING	EXISTING	EXISTING			
302	EXISTING	EXISTING	EXISTING			
303	EXISTING	EXISTING	EXISTING			
304	EXISTING	EXISTING	EXISTING			
305	EXISTING	EXISTING	EXISTING			
309A	В	WD	HS-5		INSTALL CARD READER DEVICE	
309B	EXISTING	EXISTING	HS-5		INSTALL CARD READER DEVICE.	
311	EXISTING	EXISTING	EXISTING			
312	EXISTING	EXISTING	EXISTING			
313	EXISTING DBL DOORS	EXISTING	EXISTING			
314	В	WD	HS-1			
315	EXISTING	EXISTING	EXISTING			
316	EXISTING	EXISTING	EXISTING			
317	EXISTING	EXISTING	EXISTING			
318	Α	WD	HS-1			
320	Α	WD	HS-1			
322	EXISTING	EXISTING	EXISTING			
323	EXISTING	EXISTING	EXISTING			
324	EXISTING	EXISTING	EXISTING	·		
325	EXISTING DBL DOORS	EXISTING	EXISTING			
327	EXISTING	EXISTING	EXISTING			
328	EXISTING	EXISTING	EXISTING			
329	EXISTING	EXISTING	EXISTING			
330	EXISTING	EXISTING	EXISTING			
331	В	WD	HS-1			
332	EXISTING	EXISTING	EXISTING			
333	EXISTING	EXISTING	EXISTING		MODIFY AS REQ'D TO RECEIVE CARD READER DEVICE.	
334	EXISTING	EXISTING	EXISTING		MODIFY AS REQ'D TO RECEIVE CARD READER DEVICE.	
335	EXISTING	EXISTING	EXISTING			
336	A	WD	HS-1			
337	EXISTING	EXISTING	EXISTING			
338	EXISTING	EXISTING	EXISTING			
339A	EXISTING	EXISTING	EXISTING			
339B	EXISTING	EXISTING	EXISTING			
339C	EXISTING	EXISTING	EXISTING			
340A	EXISTING DBL DOORS	EXISTING	EXISTING		MODIFY AS REQ'D TO RECEIVE CARD READER DEVICE.	
340B	EXISTING DBL DOORS	EXISTING	EXISTING		MODIFY AS REQ'D TO RECEIVE CARD READER DEVICE.	
342A	EXISTING	EXISTING	EXISTING			
342B	EXISTING	EXISTING	EXISTING			
350A	EXISTING	EXISTING	EXISTING		MODIFY AS REQ'D TO RECEIVE CARD READER DEVICE.	
350B	EXISTING	EXISTING	EXISTING		MODIFY AS REQ'D TO RECEIVE CARD READER DEVICE.	
400	С	WD	HS-2		INSTALL CARD READER DEVICE.	
400A	EXISTING DBL DOORS	EXISTING	EXISTING			
400B	EXISTING DBL DOORS	EXISTING	EXISTING			
401A	С	WD	HS-3			

		I			
	402	EXISTING	EXISTING	EXISTING	
T	403	EXISTING	EXISTING	EXISTING	
F	404	EXISTING	EXISTING	EXISTING	
	405	EXISTING	EXISTING	EXISTING	
 	406	В	W D	HS-6	INSTALL CARD READER DEVICE.
┢	408A	В	WD	HS-6	INSTALL CARD READER DEVICE.
 	408B	В	WD	HS-6	INSTALL CARD READER DEVICE.
F	410	В	W D	HS-2	INSTALL CARD READER DEVICE.
-	411	EXISTING	EXISTING	EXISTING	
F	412	EXISTING	EXISTING	EXISTING	
\vdash	413	EXISTING	EXISTING	EXISTING	
f	414	Α	W D	HS-1	
ŀ	416	EXISTING	EXISTING	EXISTING	
r	417	EXISTING	EXISTING	EXISTING	
-	418	EXISTING	EXISTING	EXISTING	
H	421	EXISTING	EXISTING	EXISTING	
f	422	EXISTING	EXISTING	EXISTING	
	423	EXISTING	EXISTING	EXISTING	
 	424	EXISTING	EXISTING	EXISTING	
ŀ	425	EXISTING	EXISTING	EXISTING	
 	429	EXISTING	EXISTING	EXISTING	MODIFY AS REQ'D TO RECEIVE CARD READER DEVICE.
-	430A	EXISTING	EXISTING	EXISTING	
-	430B	EXISTING	EXISTING	EXISTING	
-	431	EXISTING	EXISTING	EXISTING	MODIFY AS REQ'D TO RECEIVE CARD READER DEVICE.
	432	EXISTING	EXISTING	EXISTING	
	433) в	WD	HS-1	
7	434	EXISTING	EXISTING	EXISTING	
f	435	EXISTING	EXISTING	EXISTING	
1	436	EXISTING	EXISTING	HS-4	
ŀ	437	EXISTING	EXISTING	EXISTING	
{}	438A	В	WD	HS-3	INSTALL KICKPLATE TO MATCH HARDWARE FINISH
	438B	В	WD	HS-3	INSTALL KICKPLATE TO MATCH HARDWARE FINISH
Ì	440A	EXISTING	EXISTING	EXISTING	
f	440B	EXISTING	EXISTING	EXISTING	
	440C	EXISTING	EXISTING	EXISTING	
ŀ	442A	EXISTING	EXISTING	EXISTING	
	442B	EXISTING	EXISTING	EXISTING	
$\uparrow\uparrow$	443A	В	WD	HS-3	INSTALL KICKPLATE TO MATCH HARDWARE FINISH.
	443B	В	WD	HS-3	INSTALL KICKPLATE TO MATCH HARDWARE FINISH.
	444	В	WD	HS-1	
1	445	EXISTING DBL DOORS	EXISTING	EXISTING	
	446	EXISTING	EXISTING	EXISTING	MODIFY AS REQ'D TO RECEIVE CARD READER DEVICE.
f	450A	EXISTING	EXISTING	EXISTING	MODIFY AS REQ'D TO RECEIVE CARD READER DEVICE.
	450B	EXISTING	EXISTING	EXISTING	MODIFY AS REQ'D TO RECEIVE CARD READER DEVICE.

HS-3

WD

Hardware Sets:	
HS-1 SINGLE NON-RATED DOOR WITH LATCHSET	HS-2 SINGLE NON-RATED DOOR WITH CARD READER
QTY 2 PAIR — BUTT HINGES QTY 1 — LEVER LATCHSET QTY 1 — BLDG STD. DOOR STOP QTY 1 SET — SILENCERS	QTY 2 PAIR — BUTT HINGES QTY 1 — LEVER LOCKSET QTY 1 — SURFACE MTD. CLOSER QTY 1 — ELECTRIC STRIKE QTY 1 — BLDG STD. DOOR STOP QTY 1 SET — SILENCERS

HS-4 SINGLE NON-RATED DOOR WITH LOCKSET HS-3 SINGLE NON-RATED LATCHING DOOR W/ CLOSER QTY 2 PAIR — BUTT HINGES QTY 1 — LEVER LOCKSET QTY 1 — BLDG STD. DOOR STOP QTY 1 SET — SILENCERS

QTY 2 PAIR — BUTT HINGES
QTY 1 — LEVER LATCHSET
QTY 1 — SURFACE MTD. CLOSER
QTY 1 — BLDG STD. DOOR STOP
QTY 1 SET — SILENCERS

HS-5 SINGLE NON-RATED LATCHING DOOR W/ PANIC HARDWARE

QTY 2 PAIR — BUTT HINGES
QTY 1 — PANIC PUSH—BAR & LEVER LATCHSET
QTY 1 — SURFACE MTD. CLOSER
QTY 1 — BLDG STD. DOOR STOP
QTY 1 SET — SILENCERS

QTY 2 PAIR - BUTT HINGES
QTY 1 - PANIC PUSH-BAR & LEVER LATCHSET
QTY 1 - SURFACE MTD. CLOSER
QTY 1 - ELETRIC STRIKE
QTY 1 - BLDG STD. DOOR STOP
QTY 1 SET - SILENCERS

HS-6 SINGLE NON-RATED LATCHING DOOR W/ PANIC HARDWARE & CARD READER

· between

REVIEWED
FEB 2 6 2014
CITY OF KIRKLAND
FIRE / BLDG

REVIEWED
REVIE

•



10.00.10	1 Citille / Dia 1994C
	.,

Door Schedule and Hardware

I-10.2

© 2013, JPC Architects, PLLC

	O - la a -la -la -						403	EXISTING	EXISTING	EXISTING		
Doo	r Schedule:						404	EXISTING	EXISTING	EXISTING		
NO.	TYPE	FRAME	HDWE	RATING	REMARKS	REVISION	405	EXISTING	EXISTING	EXISTING		
	EXISTING	EXISTING	EXISTING	1011110	TCENT UTC	1.2.1.0.01	406	В	WD	HS-6	INSTALL CARD READER DEVICE.	
300A			EXISTING			<u> </u>	408A	В	WD	HS-6	INSTALL CARD READER DEVICE.	
300B	EXISTING	EXISTING	EXISTING				408B	В	WD	HS-6	INSTALL CARD READER DEVICE.	
302	EXISTING EXISTING	EXISTING EXISTING	EXISTING			<u> </u>	410	В	WD	HS-2	INSTALL CARD READER DEVICE.	
303	EXISTING	EXISTING	EXISTING				411	EXISTING	EXISTING	EXISTING		
304	EXISTING	EXISTING	EXISTING				412	EXISTING	EXISTING	EXISTING		
309A	B	WD	HS-5		INSTALL CARD READER DEVICE		413	EXISTING	EXISTING	EXISTING		
309A 309B	В	WD	HS-5	<u> </u>	INSTALL CARD READER DEVICE.		414	A	WD	HS-1		
ļ	EXISTING	EXISTING	EXISTING		INSTALL GARD REPORT SERVEL	 	416	EXISTING	EXISTING	EXISTING		
311	EXISTING	EXISTING	EXISTING				417	EXISTING	EXISTING	EXISTING		
	EXISTING DBL DOORS	EXISTING	EXISTING				418	EXISTING	EXISTING	EXISTING		
313	B		HS-1				421	EXISTING	EXISTING	EXISTING		
314		WD EXISTING	EXISTING				422	EXISTING	EXISTING	EXISTING		
315	EXISTING EXISTING	EXISTING	EXISTING				423	EXISTING	EXISTING	EXISTING		
316	VI. 10. 10. 10. 10. 10. 10. 10. 10. 10. 10		EXISTING				424	EXISTING	EXISTING	EXISTING		
317	EXISTING	EXISTING	HS-1				425	EXISTING	EXISTING	EXISTING		
318	A	WD	HS-1				429	EXISTING	EXISTING	EXISTING	MODIFY AS REQ'D TO RECEIVE CARD READER DEVIC	Ε.
320	A	WD	EXISTING				430A	EXISTING	EXISTING	EXISTING		
322	EXISTING	EXISTING	EXISTING	-			430B	EXISTING	EXISTING	EXISTING		
323	EXISTING	EXISTING EXISTING	EXISTING				431	EXISTING	EXISTING	EXISTING	MODIFY AS REQ'D TO RECEIVE CARD READER DEVIC	E
324	EXISTING EXISTING DBL DOORS	EXISTING	EXISTING				432	EXISTING	EXISTING	EXISTING		
325	EXISTING DBL DOORS EXISTING	EXISTING	EXISTING		A44-0		433	EXISTING	EXISTING	EXISTING	• • • • • • • • • • • • • • • • • • • •	\rightarrow
327		EXISTING	EXISTING				434	EXISTING	EXISTING	EXISTING		
328	EXISTING EXISTING	EXISTING	EXISTING				435	EXISTING	EXISTING	EXISTING		
329	EXISTING	EXISTING	EXISTING				436	EXISTING	EXISTING	EXISTING		
330	B	WD	HS-1	-			437	В	WD	HS-4		
	EXISTING	EXISTING	EXISTING				438	A	WD	HS-3	INSTALL KICKPLATE TO MATCH HARDWARE FINISH.	
332	EXISTING	EXISTING	EXISTING	-	MODIFY AS REQ'D TO RECEIVE CARD READER DEVICE.		439A	EXISTING	EXISTING	EXISTING		
333	EXISTING	EXISTING	EXISTING		MODIFY AS REQ'D TO RECEIVE CARD READER DEVICE.		439B	EXISTING	EXISTING	EXISTING		
334	EXISTING	EXISTING	EXISTING		MODIFT AS REQ D TO RECEIVE CARD READER DEVICE.		439C	EXISTING	EXISTING	EXISTING		
336	A	WD	HS-1	-			440A	EXISTING DBL DOORS	EXISTING	EXISTING		
337	EXISTING	EXISTING	EXISTING				440B	EXISTING DBL DOORS	EXISTING	EXISTING		
	EXISTING	EXISTING	EXISTING	_			441	В	WD	HS-1		
338	EXISTING	EXISTING	EXISTING	-			442A	EXISTING	EXISTING	EXISTING		
339A			EXISTING				442B	EXISTING	EXISTING	EXISTING		
339B	EXISTING	EXISTING EXISTING	EXISTING			+	443	В	WD	HS-3	INSTALL KICKPLATE TO MATCH HARDWARE FINISH.	\bot
339C	EXISTING DRI DOORS	EXISTING	EXISTING		MODIFY AS REQ'D TO RECEIVE CARD READER DEVICE.		445	EXISTING DBL DOORS	EXISTING	EXISTING		
340A	EXISTING DBL DOORS		EXISTING	-	MODIFY AS REQ'D TO RECEIVE CARD READER DEVICE. MODIFY AS REQ'D TO RECEIVE CARD READER DEVICE.		446	EXISTING	EXISTING	EXISTING	MODIFY AS REQ'D TO RECEIVE CARD READER DEVICE	E.
340B	EXISTING DBL DOORS	EXISTING	EXISTING		MODIFT AS REQ D TO RECEIVE CARD READER DEVICE.		450A	EXISTING	EXISTING	EXISTING	MODIFY AS REQ'D TO RECEIVE CARD READER DEVICE	Æ.
342A	EXISTING	EXISTING					450B	EXISTING	EXISTING	EXISTING	MODIFY AS REQ'D TO RECEIVE CARD READER DEVICE	E.
342B	EXISTING	EXISTING	EXISTING		LICENSE AND DESIGN TO DESCRIPT CARD DEADED DOUGE		<u> </u>					

MODIFY AS REQ'D TO RECEIVE CARD READER DEVICE.

MODIFY AS REQ'D TO RECEIVE CARD READER DEVICE.

INSTALL CARD READER DEVICE.

350A

401B

EXISTING

EXISTING

EXISTING

EXISTING


EXISTING

EXISTING

HS-3

EXISTING

Hardware Sets:									
HS-1 SINGLE NON-RATED DOOR WITH LATCHSET QTY 1-1/2 PAIR - BUTT HINGES QTY 1 - LEVER LATCHSET QTY 1 - BLDG STD. DOOR STOP QTY 1 SET - SILENCERS	HS-2 SINGLE NON-RATED DOOR WITH CARD READER QTY 1-1/2 PAIR - BUTT HINGES QTY 1 - LEVER LOCKSET QTY 1 - SURFACE MTD. CLOSER QTY 1 - ELECTRIC STRIKE QTY 1 - BLDG STD. DOOR STOP								
HS-3 SINGLE NON-RATED LATCHING DOOR W/ CLOSER	QTY 1 SET — SILENCERS HS—4 SINGLE NON—RATED DOOR WITH LOCKSET								
QTY 1-1/2 PAIR - BUTT HINGES QTY 1 - LEVER LATCHSET QTY 1 - SURFACE MTD. CLOSER QTY 1 - BLDG STD. DOOR STOP QTY 1 SET - SILENCERS	QTY 1-1/2 PAIR - BUTT HINGES QTY 1 - LEVER LOCKSET QTY 1 - BLDG STD. DOOR STOP QTY 1 SET - SILENCERS								
HS-5 SINGLE NON-RATED LATCHING DOOR W/ PANIC HARDWARE	HS-6 SINGLE NON-RATED LATCHING DOOR W/ PANIC HARDWARE & CARD READER								
QTY 1-1/2 PAIR - BUTT HINGES QTY 1 - PANIC PUSH-BAR & LEVER LATCHSET QTY 1 - SURFACE MTD. CLOSER QTY 1 - BLDG STD. DOOR STOP QTY 1 SET - SILENCERS	QTY 1-1/2 PAIR - BUTT HINGES QTY 1 - PANIC PUSH-BAR & LEVER LATCHSET QTY 1 - SURFACE MTD. CLOSER QTY 1 - ELETRIC STRIKE QTY 1 - BLDG STD. DOOR STOP QTY 1 SET - SILENCERS								

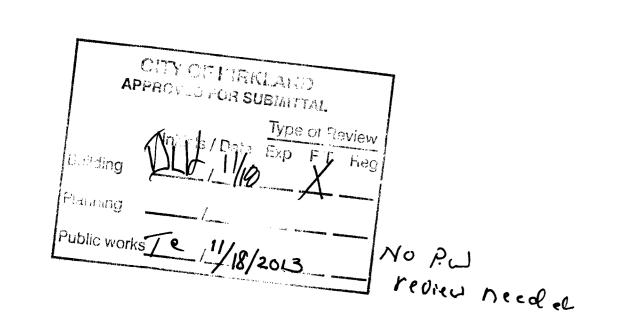


NO FLAMING REVIEW

NECESCRATY VIBITS- PIET Kurt Miller, applicant

this application does not involve any
change in use (office-Office) nor

any external changes.

Cephical .

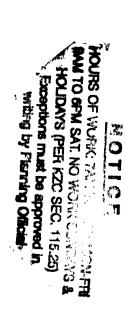

DEC 0.4 2013
CITY OF KIRKLAND FIRE / BLDG

FINAL 4-4-14 3006 LEON

CITY OF KIRKLAND
BUILDING DEPARTMENT

PERMIT # BNR13-06685 PLAN CASE BNRP13-02061

ADDRESS 4400 CARILLON PT
WORK CLASS INTERIOR ALTERATION
PROJECT
OWNER CARILLON PROPERTIES
DT SUBMITTED 11/18/2013
DT APPROVED
APPROVED BY

Bld